

LA MESA ARTS ACADEMY CULINARY CLASSROOM

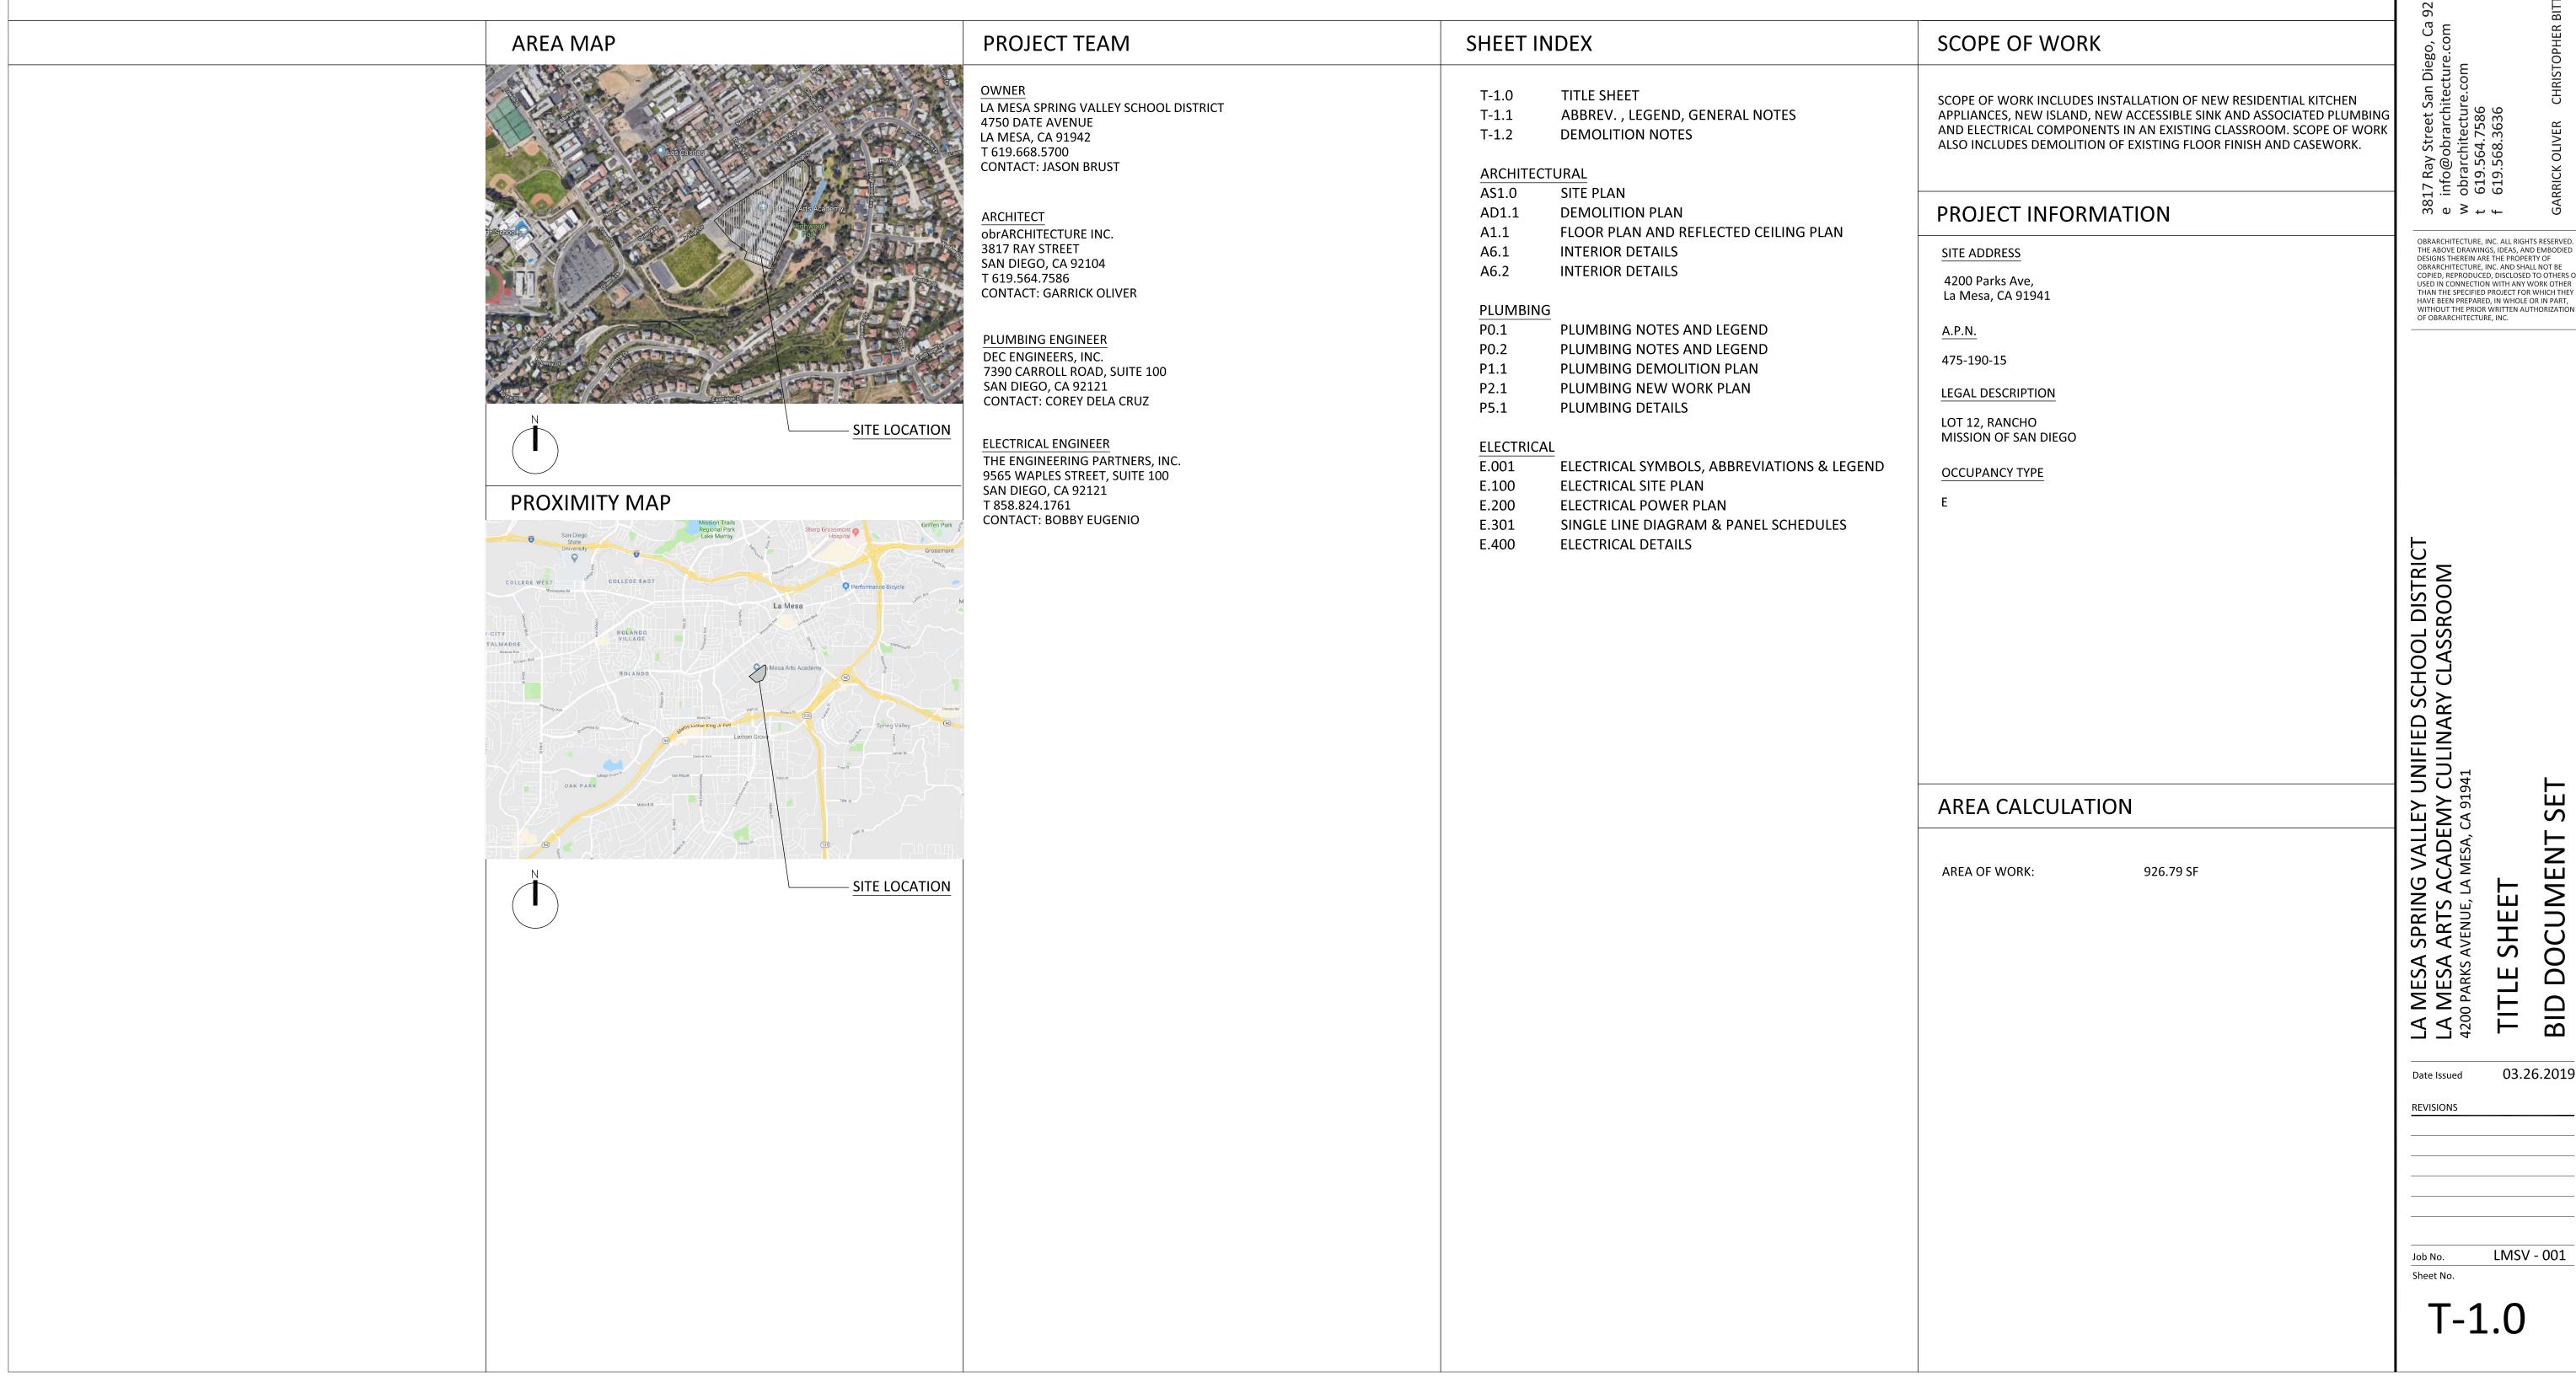

03.26.2019

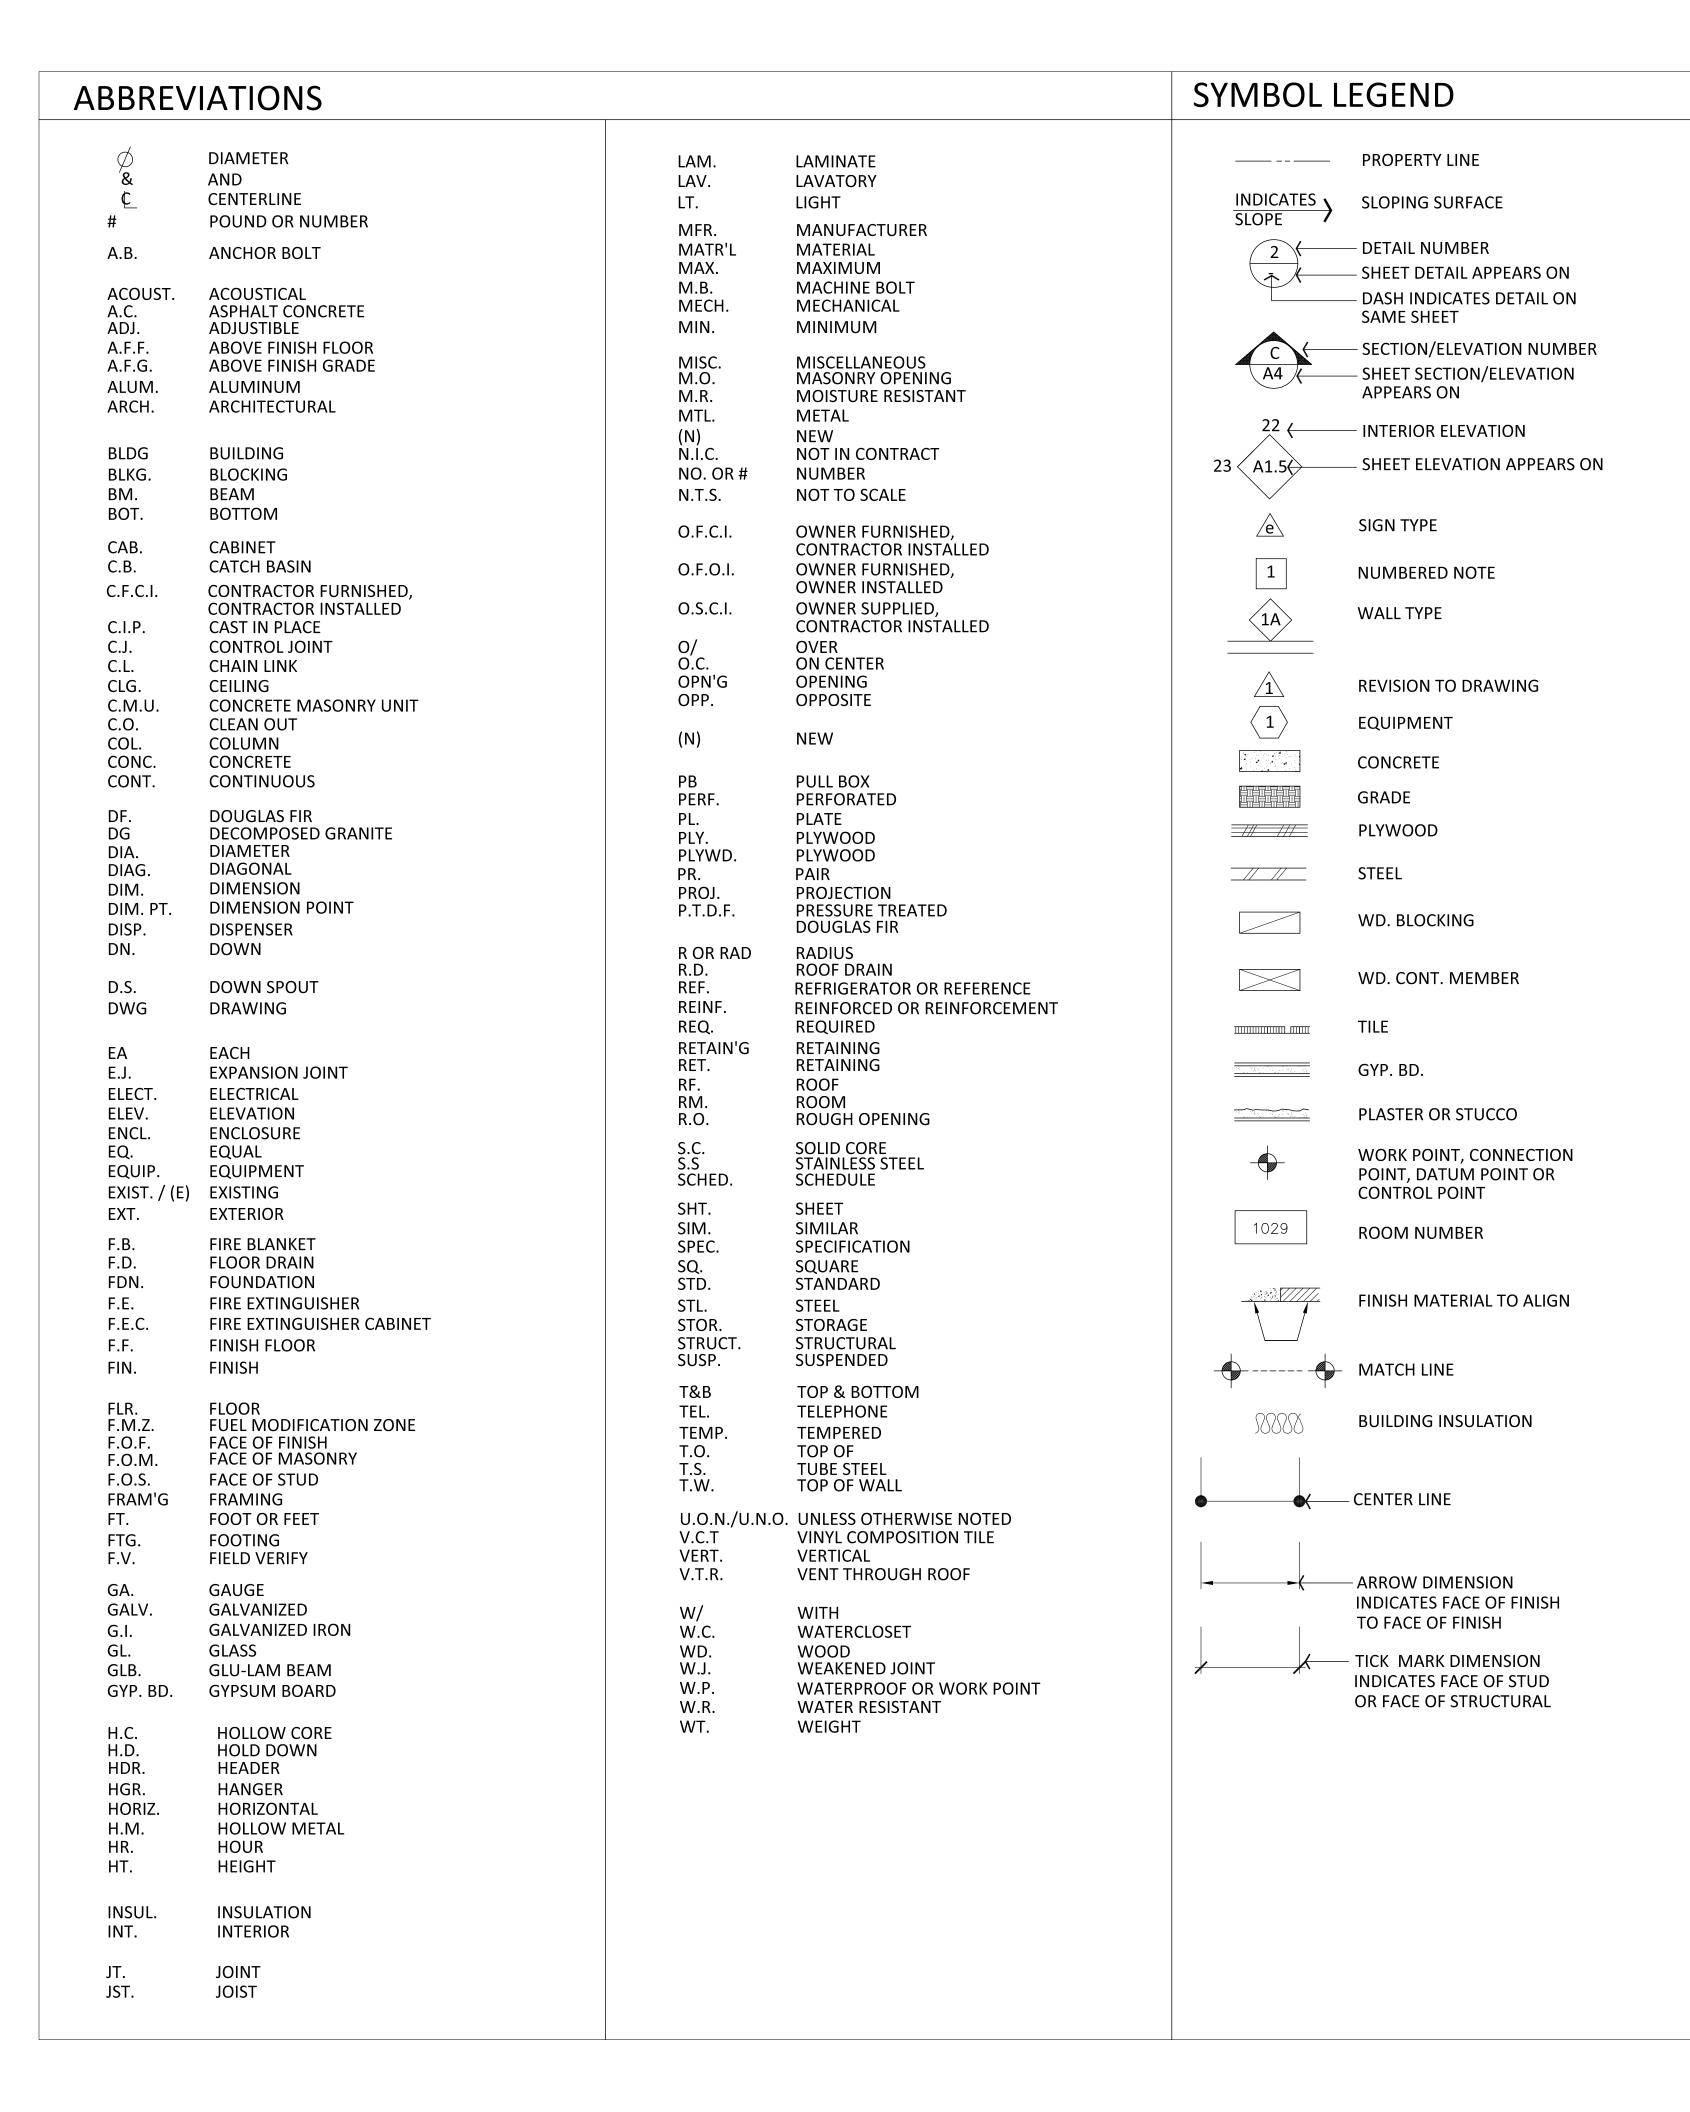

APPLICABLE CODES

CONSTRUCTION SHALL COMPLY WITH THE FOLLOWING PARTS OF THE TITLE 24 OF THE CALIFORNIA CODE OF **REGULATIONS (CCR)**

2016 BUILDING STANDARDS ADMINISTRATIVE CODE PART 1, TITLE 24 C.C.R.

2016 CALIFORNIA BUILDING CODE (CBC), PART 2, TITLE 24

(2015 INTERNATIONAL BUILDING CODE, VOL 1-2 AND 2013 CALIFORNIA AMENDMENTS)

2016 CALIFORNIA ELECTRICAL CODE (CEC) PART 3, TITLE 24 C.C.R.;

(2014 NATIONAL ELECTRICAL CODE, AND 2013 CALIFORNIA AMENDMENTS)

2016 CALIFORNIA PLUMBING CODE (CPC), PART 5, TITLE 24

(2015 UNIFORM PLUMBING CODE, AND 2013 CALIFORNIA AMENDMENTS)

2016 CALIFORNIA ENERGY CODE, PART 6, TITLE 24 C.C.R.;

2016 CALIFORNIA FIRE CODE (CFC), PART 9, TITLE 24 C.C.R.; (2015 INTERNATIONAL FIRE CODE, AND 2013 **CALIFORNIA AMENDMENTS)**

2016 CALIFORNIA GREEN BUILDING STANDARDS CODE (CALGreen), PART 11, TITLE 24 C.C.R.;

2016 CALIFORNIA REFERENCED STANDARDS CODE, PART 12, TITLE 24 C.C.R.;

TITLE 19, C.C.R, PUBLIC SAFETY, STATE FIRE MARSHAL **REGULATIONS**

**ASSOCIATED AMENDMENTS IN THE SAN DIEGO MUNICIPAL CODE (SDMC)

GENERAL NOTES

- 1. THE CONTRACTOR SHALL BE RESPONSIBLE FOR MAINTAINING THAT ALL WORKMANSHIP, MATERIALS AND CONSTRUCTION SHALL BE IN COMPLIANCE WITH THE APPLICABLE CODES AND FEDERAL REQUIREMENTS AND REGULATIONS.
- 2. THE CONTRACTOR SHALL VISIT THE SITE AND VERIFY ALL DIMENSIONS PRIOR TO SUBMITTING A BID. THE CONTRACTOR IS ALSO RESPONSIBLE FOR OBTAINING ALL REQUIRED PERMITS.
- 3. THE CONTRACTOR SHALL VERIFY ALL EXISTING CONDITIONS, GRADES, ELEVATIONS AND DIMENSIONS BEFORE STARTING WORK. THE ARCHITECT SHALL BE NOTIFIED IMMEDIATELY OF ANY DISCREPANCIES OR INCONSISTENCIES.
- 4. THE CONTRACTOR SHALL DETERMINE THE LOCATION OF ALL EXISTING UTILITY SERVICES IN THE AREA TO BE EXCAVATED PRIOR TO THE BEGINNING OF EXCAVATION. THE CONTRACTOR SHALL PROTECT ALL UTILITY LINES, SERVICE LINES TO REMAIN WHICH ARE ENCOUNTERED DURING CONSTRUCTION.
- 5. THE CONTRACTOR SHALL BE RESPONSIBLE FOR THE ENFORCEMENT OF FEDERAL AND STATE OF CALIFORNIA OCCUPATIONAL SAFETY AND HEALTH ADMINISTRATION REQUIREMENTS AND REGULATIONS.
- 6. DO NOT SCALE ANY DRAWINGS IN THIS SET.
- 7. ALL DIMENSIONS SHALL TAKE PRECEDENCE OVER SCALE SHOWN ON PLANS, SECTIONS AND DETAILS. SPECIFIC NOTES AND DETAILS SHALL TAKE PRECEDENCE OVER GENERAL NOTES AND TYPICAL DETAILS.
- 8. ALL OMISSIONS AND CONFLICTS BETWEEN THE VARIOUS ELEMENTS OF THE WORKING DRAWINGS AND/OR SPECIFICATIONS SHALL BE BROUGHT TO THE ATTENTION OF THE ARCHITECT IMMEDIATELY BEFORE PROCEEDING WITH ANY WORK SO INVOLVED. NO CHANGES ARE TO BE MADE UNLESS THE ARCHITECT AND THE OWNER ARE NOTIFIED IN WRITING AND APPROVE SUCH A CHANGE ACCORDING TO THE CONTRACT.
- 9. THE ARCHITECT IS NOT RESPONSIBLE FOR ASBESTOS ABATEMENT.
- 10. PROVIDE BACKING AT ALL INDICATED FIXTURES, SIGNS, CASEWORK, HANDRAILS, ETC. LOCATIONS.
- 11. DURING CONSTRUCTION PERIOD, CONSTRUCTION OF MATERIALS SHALL BE SPREAD OUT IF PLACED ON FRAMED FLOORS OR ROOF. THE LOAD SHALL NOT EXCEED THE DESIGN LIVE LOADS FOR EACH PARTICULAR LEVEL.

GENERAL NOTES, CONT'D.

- 12. ITEMS SHOWN AS N.I.C. ON PLANS MAY REQUIRE SEPARATE SUBMITTALS, APPROVALS AND PERMITS. INSTALLING CONTRACTOR(S) IS RESPONSIBLE FOR OBTAINING PERMITS FOR SUCH ITEMS.
- 13. CONTRACTOR SHALL ENSURE ALL FLOOR FINISH MATERIALS WILL BE FLUSH WITH ADJACENT WALKING SURFACES, INCLUDING WHERE NEW FINISH SURFACE MATERIAL JOIN EXISTING TO PROVIDE **SMOOTH TRANSITION.**
- 14. CONTRACTOR SHALL BE RESPONSIBLE FOR PROVIDING AND INSTALLING ALL DEVICES, CONDUIT/PATHWAY, WIRING AND CONNECTIONS FOR ALL PLUMBING AND ELECTRICAL SYSTEMS.
- 15. THE DRAWINGS CONTAINED HEREIN SHALL BE CONSIDERED AS ONE COMPREHENSIVE SET OF DOCUMENTS AND SHALL NOT BE CONSIDERED AS COMPLETE SUB-SETS DIVIDED BY DISCIPLINE. THE GENERAL CONTRACTOR SHALL BE RESPONSIBLE FOR ALL INFORMATION CONTAINED HEREIN, REGARDLESS OF TRADE OR DISCIPLINE.
- 16. CONTRACTOR SHALL DEVELOP AND SUBMIT A CONSTRUCTION WASTE MANAGEMENT PLAN IN COMPLIANCE WITH CALGREEN **SECTION 5.408.1.**
- 17. CONTRACTOR SHALL RECYCLE/REUSE 50% OF NON-HAZARDOUS CONSTRUCTION WASTE OR COMPLY WITH LOCAL CONSTRUCTION / DEMOLITION WASTE MANAGEMENT ORDINANCE, WHICHEVER IS MORE STRINGENT, AND SUBMIT ALL WASTE/RECYCLE RECEIPT TICKETS TO ARCHITECT/OWNER.
- 18. CONTRACTOR SHALL X-RAY EXISTING CONCRETE STRUCTURE EACH AND EVERY TIME THE EXISTING CONCRETE STRUCTURE IS REQUIRED TO BE CORED OR CUT FOR NEW WORK, TO DETERMINE AND VERIFY LOCATION OF EXISTING STEEL REINFORCEMENT/TENSION TENDONS.



OBRARCHITECTURE, INC. ALL RIGHTS RESERVED. DESIGNS THEREIN ARE THE PROPERTY OF COPIED REPRODUCED DISCLOSED TO OTHERS THAN THE SPECIFIED PROJECT FOR WHICH THE HAVE BEEN PREPARED, IN WHOLE OR IN PAR WITHOUT THE PRIOR WRITTEN AUTHORIZATION OF OBRARCHITECTURE, INC.

EN U 8 S Z ATIO П S BREVI ENT SPRING ARTS AC CUMI $\mathbf{\Omega}$

OL DISTRICASSROOM

UNIFIED SCHO
CULINARY CLA

Date Issued	03.26.2019

LMSV - 001

Ö

0


 $\check{\Box}$


BID

Sheet No.

REVISIONS


T-1.1

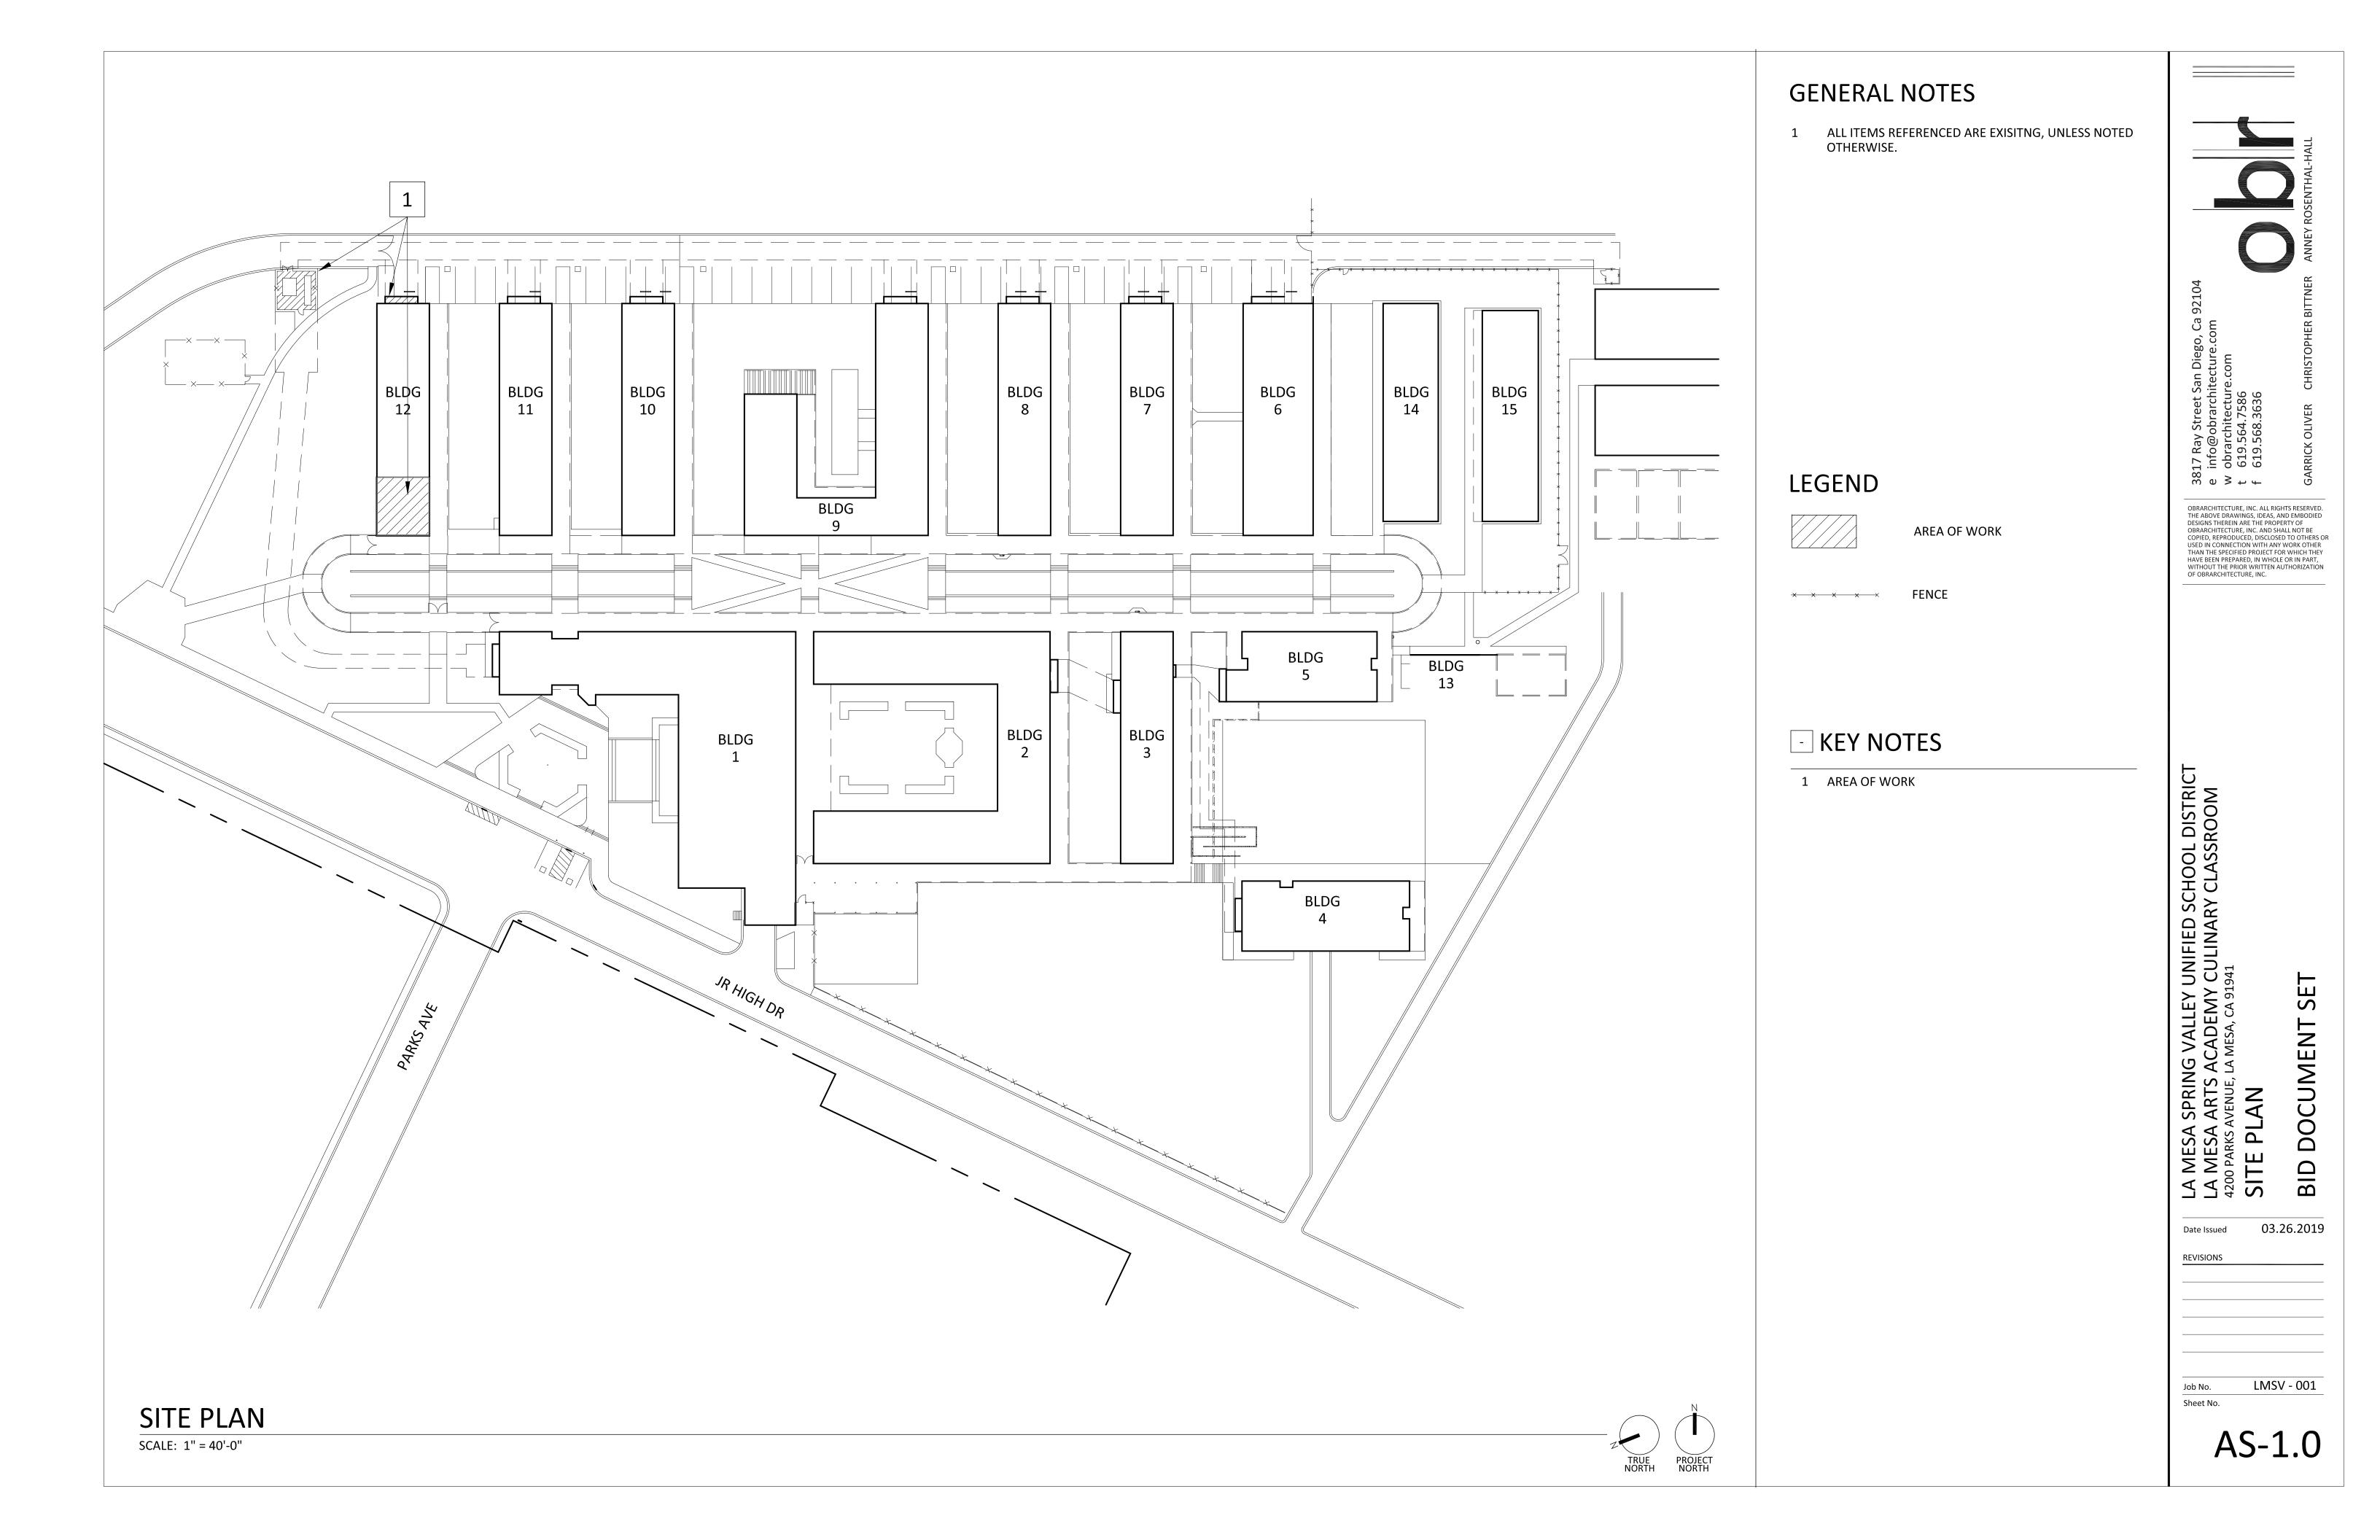

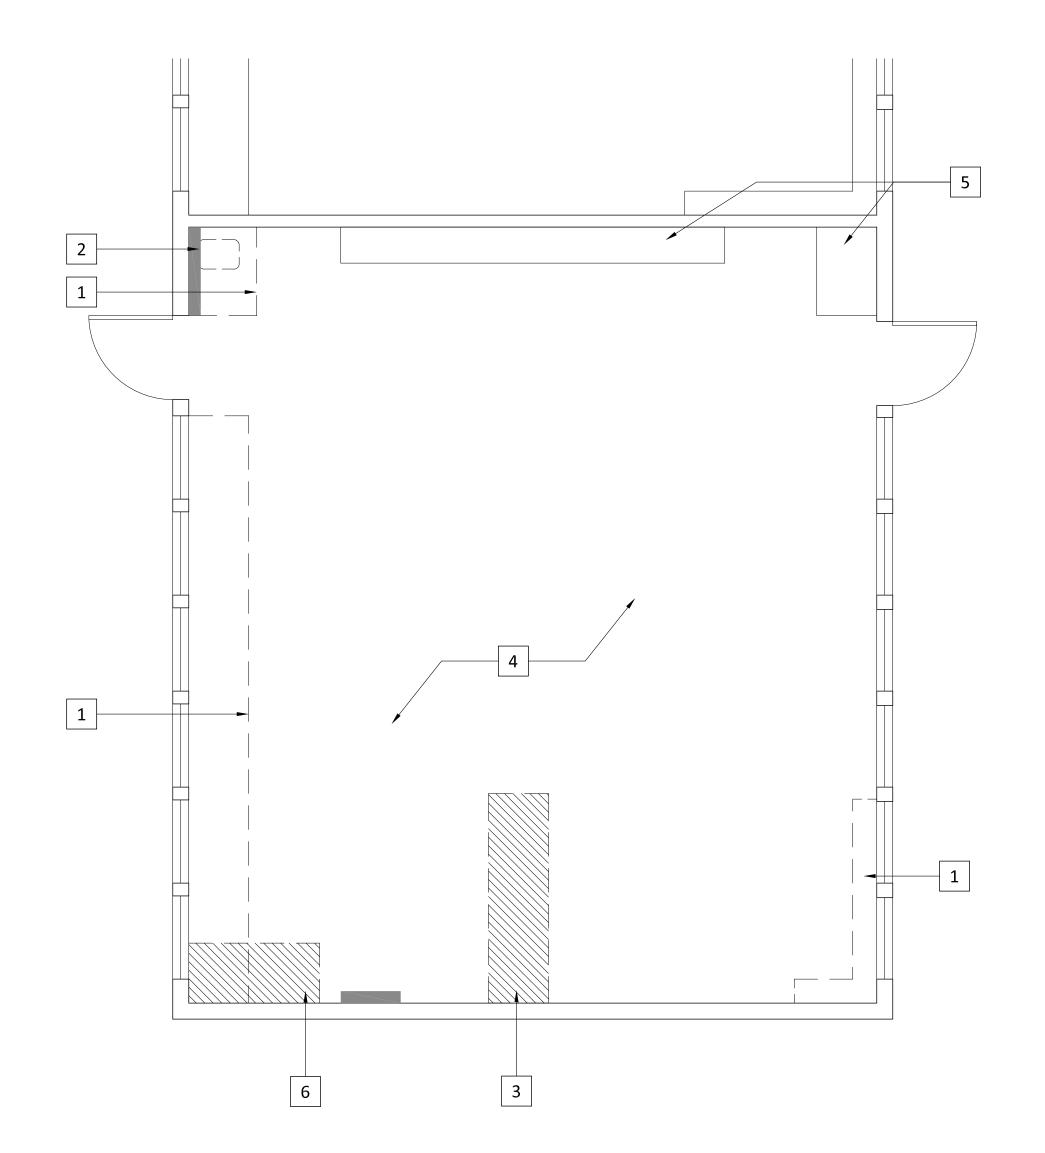



- 1 ALL ITEMS REFERENCED ARE EXISTING, UNLESS NOTED OTHERWISE.
- CONTRACTOR TO LOCATE EXISTING SEWER PIPE PRIOR TO DEMOLITION OF FLOOR FOR NEW PLUMPING

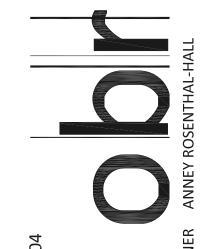

OBRARCHITECTURE, INC. ALL RIGHTS RESERVED. THE ABOVE DRAWINGS, IDEAS, AND EMBODIED DESIGNS THEREIN ARE THE PROPERTY OF DESIGNS THEREIN ARE THE PROPERTY OF OBRARCHITECTURE, INC. AND SHALL NOT BE COPIED, REPRODUCED, DISCLOSED TO OTHERS OR USED IN CONNECTION WITH ANY WORK OTHER THAN THE SPECIFIED PROJECT FOR WHICH THEY HAVE BEEN PREPARED, IN WHOLE OR IN PART, WITHOUT THE PRIOR WRITTEN AUTHORIZATION OF OBRARCHITECTURE, INC.

- KEY NOTES

LEGEND

1 DEMOLISH AND DISPOSE OF CASEWORK

--- Item to be demolished

DEMOLISH AND DISPOSE OF FLOORING AS

REQUIRED FOR NEW PLUMBING AND ELECTRICAL

- 2 DEMOLISH AND DISPOSE OF SINK
- 3 DEMOLISH PORTION OF FLOOR FOR (N) ELECT. CONDUIT, SEE ELECTRICAL DRAWINGS AND DETAIL 19/A-6.1 REPLACE DEMOLISHED POTION OF FLOOR WITH (N) CONCRETE FLOOR TO MATCH (E) ADJACENT CONCRETE SECTION
- 4 DEMOLISH AND DISPOSE OF EXISTING CARPET FLOORING AND VAT FLOORING IN ENTIRELY, PREPARE FOR NEW WORK
- 5 CASEWORK TO REMAIN, PROTECT IN PLACE
- 6 DEMOLISH PORTION OF FLOOR AS REQUIRED TO TIE NEW PLUMBING WORK TO EXISTING, SEE PLUMBING **DRAWINGS**

LA MESA SPRING VALLEY UNIFIED SCHOOL DISTRICT
LA MESA ARTS ACADEMY CULINARY CLASSROOM
4200 PARKS AVENUE, LA MESA, CA 91941


DEMOLITION PLAN SET

DOCUMENT


03.26.2019

LMSV - 001

AD-1.1

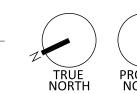

1/4" = 1'-0"

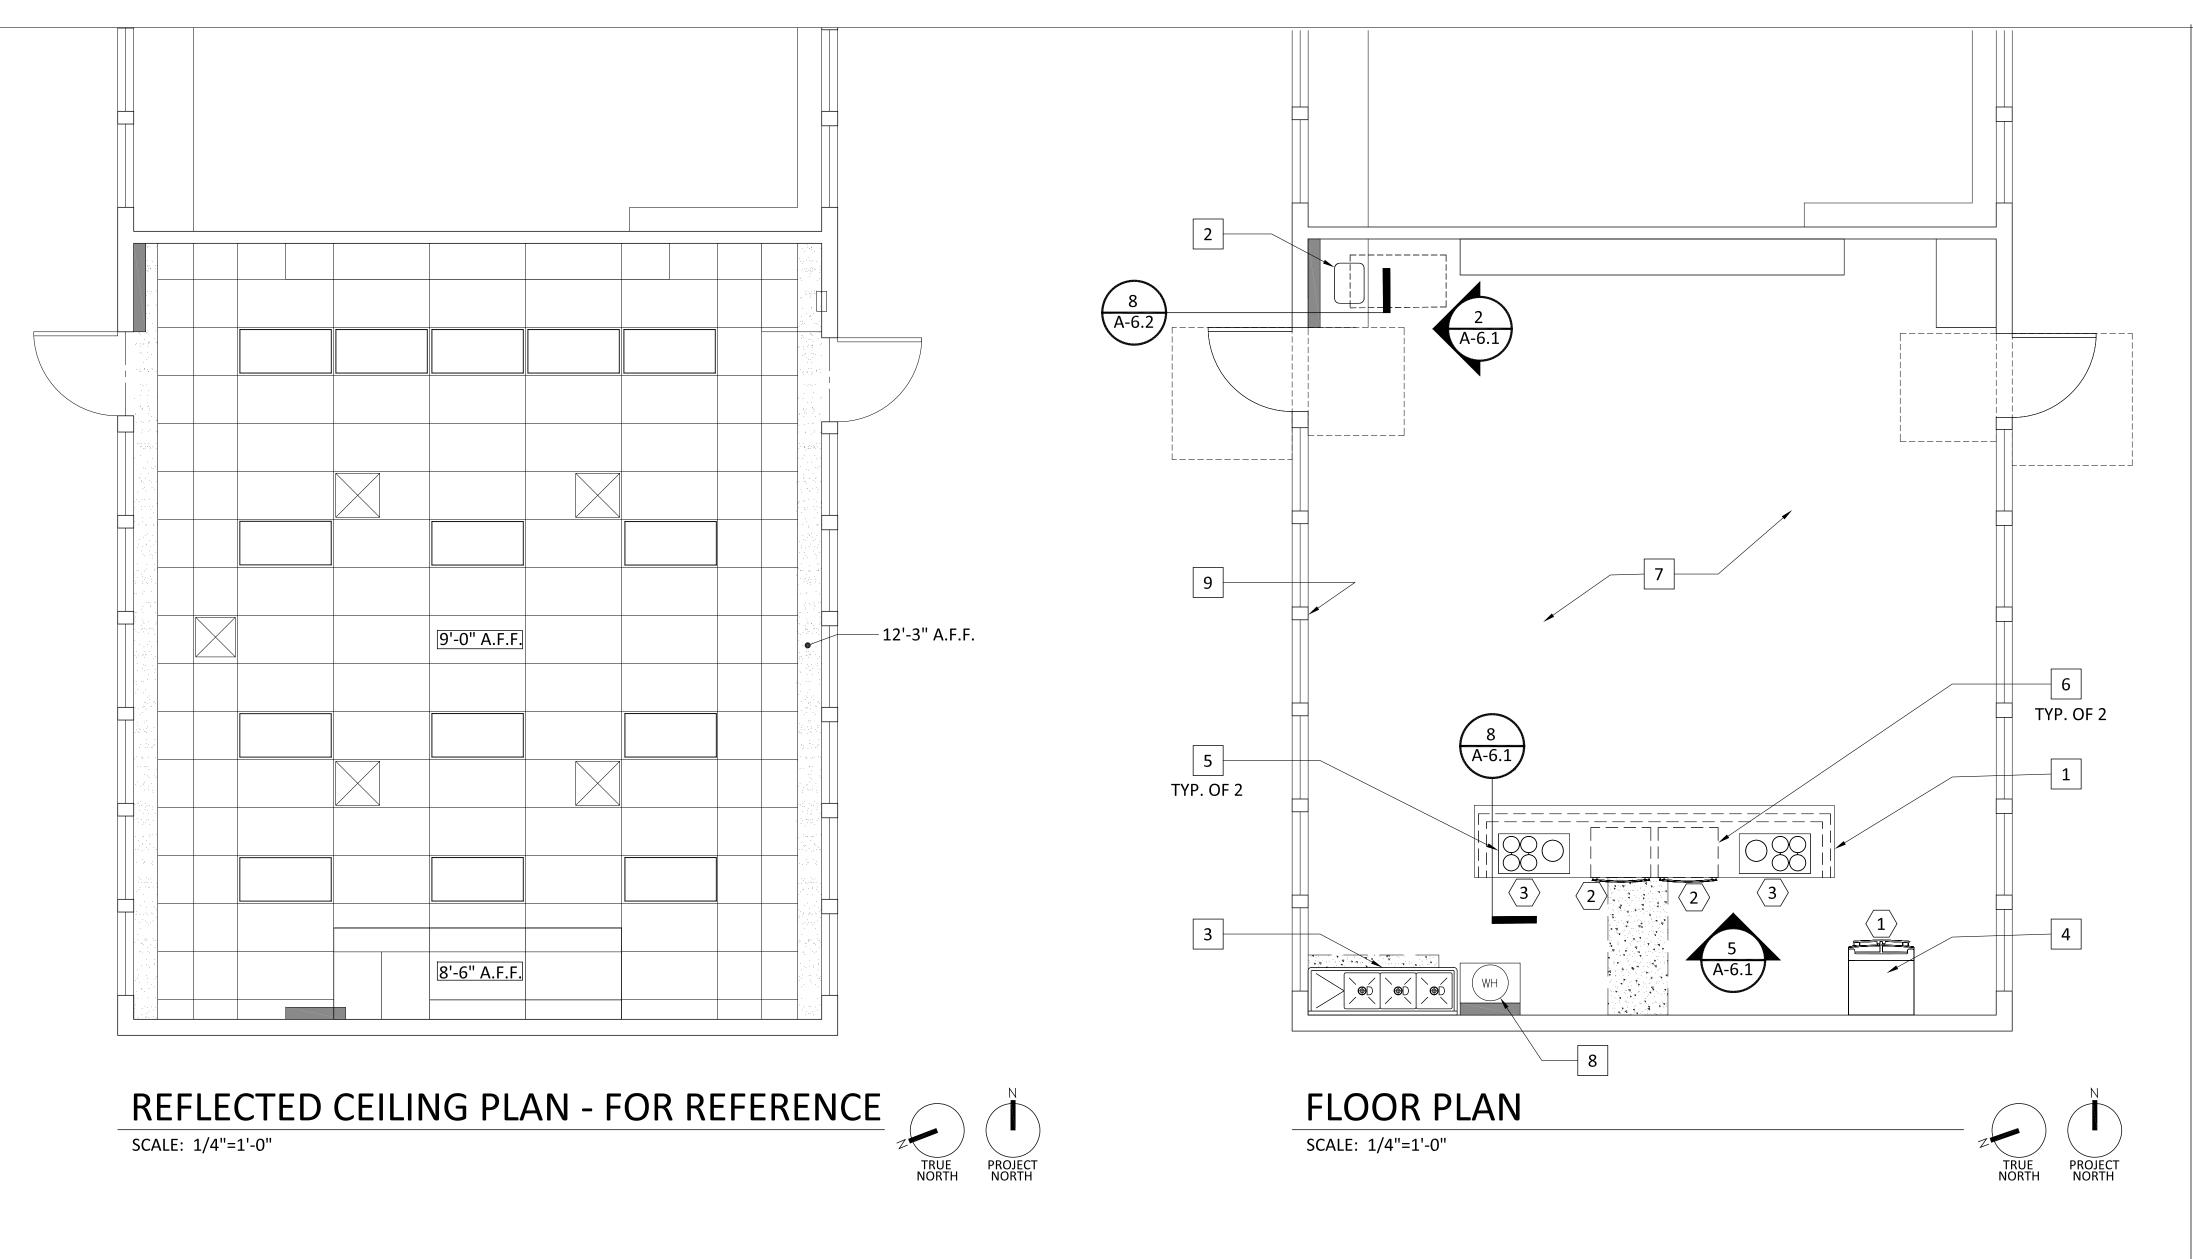

GENERAL NOTES

- ALL ITEMS REFERENCED ARE EXISTING, UNLESS NOTED OTHERWISE.
- ALL INTERIOR WALLS TO BE PAINTED.
- WHERE WALLS DAMAGED FROM DEMO PATCH AS REQUIRED AND PAINT TO MATCH ADJACENT WALL
- ROUTE (N) PLUMBING PIPING ABOVE SUSPENDED CEILING, SEE PLUMBING DRAWINGS.
- ROUTE (N) ELECTRICAL CONDUIT FROM (N) TRANSFORMER TO (N) ELECTRICAL PANEL ABOVE SUSPENDED CEILING - SEE ELECTRICAL DRAWINGS.

LEGEND

SUSPENDED GYPSUM BOARD CEILING

SUSPENDED 2'X4' ACOUSTICAL CEILING TILES & GRID

(N) CONCRETE FLOOR TO MATCH ADJACENT

2'X4' LIGHT FIXTURE

SUPPLY DIFFUSER

RETURN REGISTER

(N) 2X4 FURRED WALL

(N) CONCRETE FLOOR PATCH PER DETAIL 13/A-6.1

KEY NOTES

- 1 NEW ISLAND CASEWORK PER 8/A-6.1
- 2 NEW ACCESSIBLE SINK PER DETAIL 8/A-6.2
- 3 NEW THREE COMPARTMENT SINK SEE PLUMBING **DRAWINGS**
- 4 NEW REFRIGERATOR C.F.C.I.
- 5 NEW COOKTOP C.F.C.I.
- 6 NEW OVEN C.F.C.I.
- 7 POLISH AND SEAL CONCRETE FLOOR
- 8 NEW WATER HEATER IN (N) CASEWORK PER DETAIL 16/A-6.2
- 9 PROVIDE (N) $\frac{5}{8}$ " GYP. BD. UNDER (E) WINDOWS WHERE CASEWORK REMOVED. RECESS (N) ELECTRICAL OUTLET INTO (N) GYP. BD. PAINT GYP, PROVIDE (N) 4" RUBBER BASE

EQUII	PMENT	SCHEDULE				
ITEM NO.	QTY	EQUIPMENT DESCRIPTION	MANUFACTURER	MODEL NUMBER	ELECTRICAL REQ'TS	REMARKS
1	1	GE APPLIANCES ENERGY STAR 24.8 Cu, Ft, FRENCH-DOOR REFRIGERATOR	GE APPLIANCES	GNE25JGK	-	
2	2	30" BUILT-IN SINGLE OVEN	MONOGRAM	ZET1.PHSS	-	-
3	2	CONTEMPORARY INDUCTION COOKTOP	WOLF	CI365C/B	50 AMPS	

THE ABOVE DRAWINGS, IDEAS, AND EMBODIED DESIGNS THEREIN ARE THE PROPERTY OF USED IN CONNECTION WITH ANY WORK OTHER THAN THE SPECIFIED PROJECT FOR WHICH THEY HAVE BEEN PREPARED, IN WHOLE OR IN PART, WITHOUT THE PRIOR WRITTEN AUTHORIZATION

OF OBRARCHITECTURE, INC.

LA MESA SPRING VALLEY UNIFIED SCHOLA MESA ARTS ACADEMY CULINARY CLA MESA AVENUE, LA MESA, CA 91941

ENLARGED FLOOR PLAN + RE

SET


DOCUMENT

BID

Date Issued	03.26.2019

LMSV - 001

A-1.1

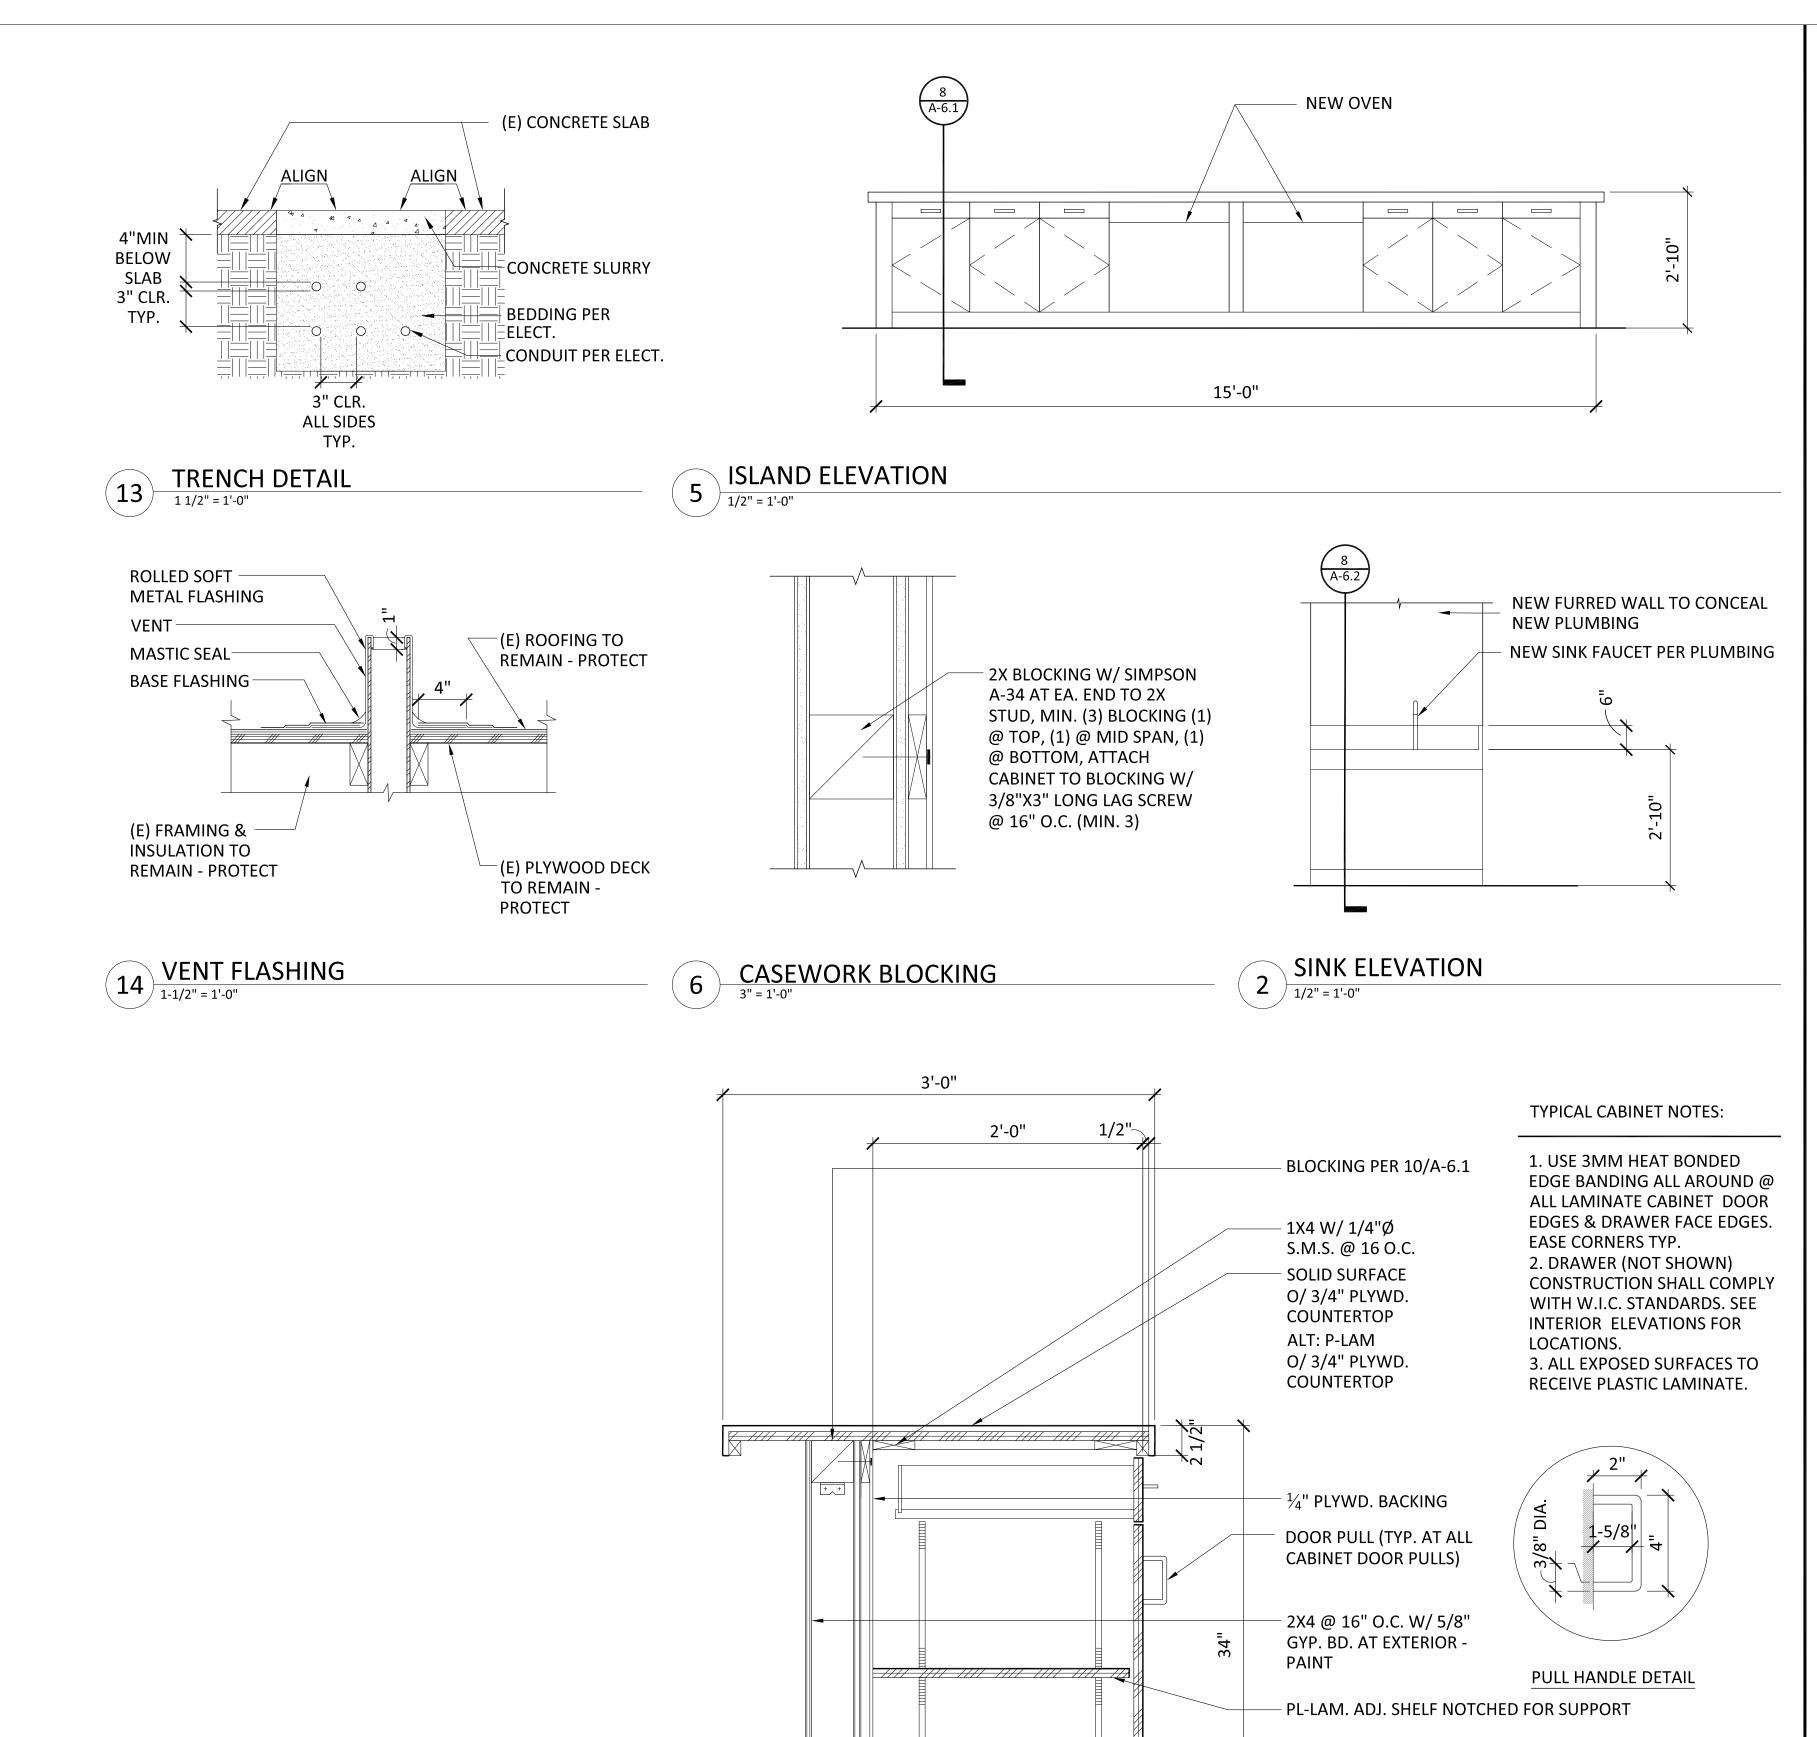

ISLAND CABINET

(8) ISLANDE 1-1/2" = 1'-0"

ANNEY ROSENTHAL-HALL

Ray Street San Diego, Ca 9210⁴ fo@obrarchitecture.com brarchitecture.com 19.564.7586

e info@obrarchite w obrarchitecture.d t 619.568.3636

OBRARCHITECTURE, INC. ALL RIGHTS RESERVED. THE ABOVE DRAWINGS, IDEAS, AND EMBODIED DESIGNS THEREIN ARE THE PROPERTY OF OBRARCHITECTURE, INC. AND SHALL NOT BE COPIED, REPRODUCED, DISCLOSED TO OTHERS OR USED IN CONNECTION WITH ANY WORK OTHER THAN THE SPECIFIED PROJECT FOR WHICH THEY HAVE BEEN PREPARED, IN WHOLE OR IN PART, WITHOUT THE PRIOR WRITTEN AUTHORIZATION OF OBRARCHITECTURE, INC.

LA MESA SPRING VALLEY UNIFIED SCHOOL DISTRICT
LA MESA ARTS ACADEMY CULINARY CLASSROOM
4200 PARKS AVENUE, LA MESA, CA 91941
INTERIOR DETAILS

INTERIOR DETAI BID DOCUMENT

SE

Date Issued 03.26.2019

REVISIONS

SURFACE MTD. MTL. SHELF SUPPORTS (TYP.)

-P.T.D.F. 2X4 W/ 3/8" Ø EXPANSION ANCHOR W/

2" MIN. EMBEDMENT @ 32" O.C. @ CONC SLABS


- 1 1/8" PLYWD. ATTACHED TO 2X SILL W/


#10X2' 1/2" WD. SCREWS 12" O.C.

– 4" RUBBER BASE, TYP.

Job No. LMSV - 001 Sheet No.

A-6.1

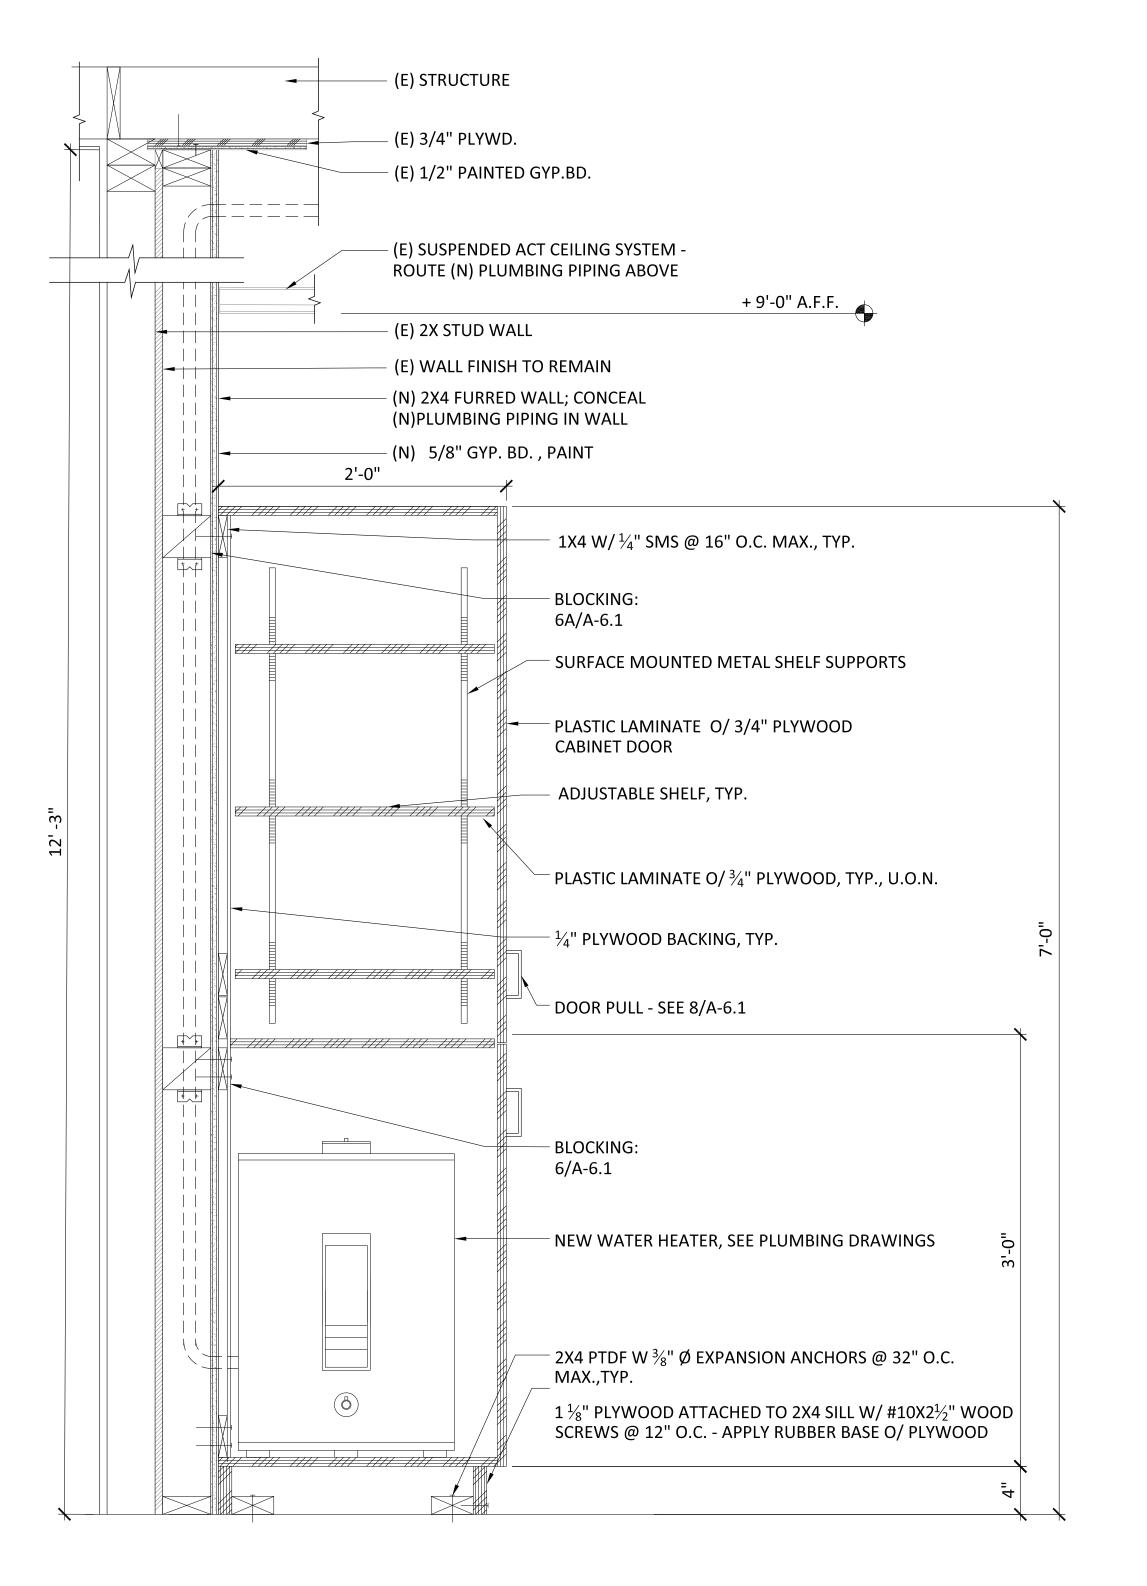

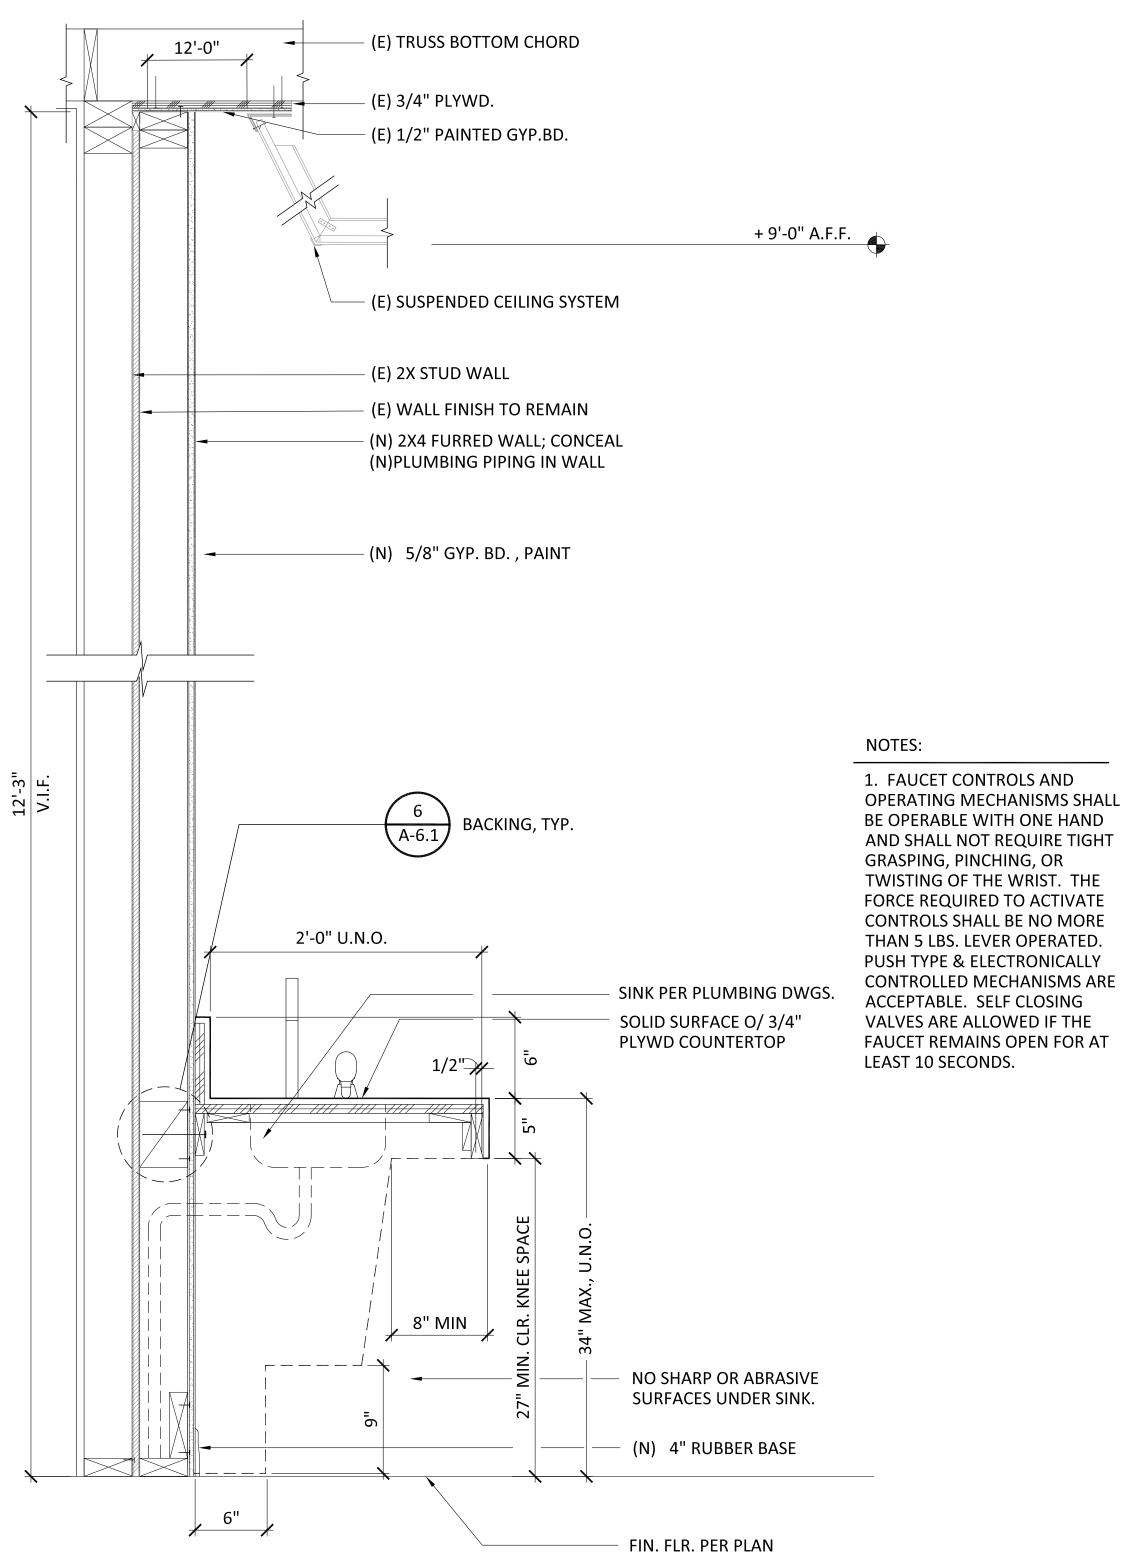

317 Ray Street San I info@obrarchitect obrarchitecture.co 619.564.7586 619.568.3636 38 f t ≪ e

OBRARCHITECTURE, INC. ALL RIGHTS RESERVED. DESIGNS THEREIN ARE THE PROPERTY OF
OBRARCHITECTURE, INC. AND SHALL NOT BE
COPIED, REPRODUCED, DISCLOSED TO OTHERS OR
USED IN CONNECTION WITH ANY WORK OTHER THAN THE SPECIFIED PROJECT FOR WHICH THEY HAVE BEEN PREPARED, IN WHOLE OR IN PART, WITHOUT THE PRIOR WRITTEN AUTHORIZATION OF OBRARCHITECTURE, INC.

' UNIFIED SCHO / CULINARY CL/ ¹⁹⁴¹

SE

DOCUMENT

03.26.2019 Date Issued

REVISIONS

LMSV - 001 Job No. Sheet No.

A-6.2

	_	LEGEND
SYMBOL	ABBR.	DESCRIPTION
•	POC	POINT OF CONNECTION
<u> </u>	POD	POINT OF DISCONNECTION
	S	SEWER OR WASTE BELOW FLOOR OR GRADE
	S OR W	SEWER OR WASTE ABOVE FLOOR OR GRADE
	GW	GREASE WASTE BELOW FLOOR OR GRADE
— SD —	SD	STORM DRAIN
— OD —	OD	OVERFLOW STORM DRAIN
	٧	SANITARY VENT
	CW	COLD WATER (DOMESTIC)
	HW	HOT WATER (DOMESTIC)
	BV	BALL VALVE
	CV	CHECK VALVE
Φ——	COTG	CLEAN-OUT TO GRADE
Φ	FCO	FLOOR CLEAN OUT
<u> </u>	WCO	WALL CLEAN-OUT OR CLEAN-OUT BELOW FLOOR
<u> </u>	CL	CAPPED LINE
G—— — =	<u> </u>	DOWN OR DROP
o— o—		UP OR RISE
+-G	НВ	HOSE BIBB
4_4_		VALVE ON RISE OR DROP
	FS	FLOOR SINK
	A/C	
	AD	AREA DRAIN
	AFF AFG	ABOVE FINISHED FLOOR ABOVE FINISHED GRADE
	AP	ACCESS PANEL
	ARCH B/G	ARCHITECT OR ARCHITECTURAL BELOW GRADE
	B/F	BELOW FLOOR
	BEL CLG	BELOW CEILING
	CONC	CONCRETE
	CONT CONTR	CONTINUATION CONTRACTOR
	DIA	DIAMETER
	DN	DOWN
	DWGS ELECT	DRAWINGS ELECTRICAL
	ELEV	ELEVATION
	EXIST *F	EXISTING DEGREES FAHRENHEIT
	FFE	FINISH FLOOR ELEVATION
	FIN FLR	FINISH OR FINISHED FLOOR
	FT	FEET OR FOOT
	GPM HDR	GALLONS PER MINUTE HEADER
	HP	HORSEPOWER
	HVAC	HEATING, VENTILATION, & AIR CONDITIONING
	I.E. INV	INVERT ELEVATION INVERT
	MAX	MAXIMUM
	MECH MFR.	MECHANICAL MANUFACTURER
	MIN	MINIMUM
	MTD N.I.C	MOUNTED NOT IN CONTRACT
	NTS	NOT TO SCALE
	NO OPER	NUMBER
	PSI	OPERATING POUNDS PER SQUARE INCH
	PSIG	POUNDS PER SQUARE INCH GAUGE
	PLBG QTY	PLUMBING QUANTITY
	SHT	SHEET
	SOV SPEC	SHUT- OFF VALVE SPECIFICATION
⊭	SQ FT	SQUARE FEET OR SQUARE FOOT
	SQ FT STRUCT	STRUCTURAL
<u></u>	SQ FT STRUCT TEMP	STRUCTURAL TEMPERATURE
<u></u>	SQ FT STRUCT	STRUCTURAL

PLUMBING PLAN CHECK NOTES

- WHERE PLUMBING PENETRATES THE FIRE RESISTIVE WALLS (AREA SEPARATION AND OCCUPANCY SEPARATION), THE SECTION PASSING THROUGH THE WALL SURFACE, AND THE FIXTURE CONNECTIONS ATTACHED THERETO, SHALL MEET CBC, FIRE AND TEMPERATURE RATING.
- 2. ALL WATER HEATERS SHALL BE LISTED IN THE CEC LIST OF APPROVED WATER HEATERS.
- ALL PLUMBING FIXTURES, AND FAUCETS SHALL COMPLY WITH CALIFORNIA GREEN BUILDING CODE MAXIMUM FLOW REQUIREMENTS PER MINUTE.(1.5 GPM FOR FAUCETS) (1.28 GPF FOR WATER CLOSETS) (1.0 GPF FOR
- I. ALL SERVICE HOT WATER PIPING SHALL BE INSULATED IN ACCORDANCE WITH CEC T-24, LATEST VERSION
- CROSS CONNECTION PROTECTION SHALL BE PROVIDED AT ALL POTABLE WATER SUPPLIED APPLIANCES AND EQUIPMENT.
- A WATER HEATER PRESSURE AND TEMPERATURE RELIEF VALVE THAT TERMINATES OUTSIDE THE BUILDING SHALL COMPLY WITH SECTION 608.5 CPC
- WATER HEATERS SHALL BE BE ANCHORED OR STRAPPED TO RESIST HORIZONTAL DISPLACEMENT DUE TO EARTHQUAKE MOTION PER SECTION 508.2 CPC
- VALVES, FIXTURES AND ALL OTHER APPURTENANCES SHALL CONFORM TO THE REQUIREMENTS OF CALIFORNIA ASSEMBLY BILL AB1953, LOW LEAD CONTENT AS APPLICABLE.
-). A WATER HEATER PRESSURE AND TEMPERATURE RELIEF DRAIN THAT TERMINATES OUTSIDE THE BUILDING SHALL COMPLY WITH SECTION 608.5 CPC.
- 10. PLUMBING FIXTURES (WATER CLOSETS AND URINALS) AND FITTINGS (FAUCETS AND SHOWERHEADS) SHALL
- MEET THE STANDARD'S REFERENCED IN TABLE 5.503.6 OF DIVISION 5.3 OF THE 2016 GREEN CODE.
- 11. EACH KITCHEN FAUCET SHALL NOT EXCEED A WATER FLOW OF 1.5 GPM.

12. DOMESTIC HOT WATER PIPING SHALL BE INSULATED PER SECTION 609.11 CPC.

- 13. BUILDING DRAIN AND VENT PIPING MATERIALS SHALL COMPLY WITH SECTIONS 701.0 AND 903.0 OF THE CALIFORNIA PLUMBING CODE.
- 14. ALL SANITARY SYSTEM MATERIALS SHALL BE LISTED BY AN APPROVED LISTING AGENCY.
- 15. EACH VENT SHALL RISE VERTICALLY TO A POINT NOT LESS THAN SIX (6) INCHES ABOVE THE FLOOD LEVEL RIM OF THE FIXTURE SERVED BEFORE OFFSETTING HORIZONTALLY OR BEFORE BEING CONNECTED TO ANY OTHER VENT.

PIPE MATERIALS SCHEDULE

DOMESTIC WATER PIPING ABOVE & BELOW GRADE, INSIDE BUILDING:

- 1. TYPE "L" COPPER TUBING, HARD DRAWN CONFORMING TO ASTM B 88, WITH WROUGHT COPPER SOLDER SWEAT FITTINGS CONFORMING TO ASTM B 16.22.
- 2. ANY WATER PIPING LOCATED BELOW GRADE SHALL BE TYPE "K" COPPER TUBING ANNEALED, WITH BRAZED JOINTS WRAPPED IN PE FILM.

SEWER WASTE & STORM DRAIN PIPING BELOW GRADE:

 SCHEDULE 40 SOLID-WALL PVC PIPE. ASTM D 2665. DRAIN. WASTE AND VENT PIPING. PVC SOCKET. FITTINGS CONFORMING TO ASTM D 2665, SOCKET TYPE, MADE TO ASTM D 3311 DRAIN, WASTE, AND VENT PATTERNS. INSTALL BELOW SLAB/GRADE PVC PIPING PER ASTM D 2321.

SEWER WASTE & STORM DRAIN PIPING ABOVE GRADE:

- CAST IRON "NO-HUB" CONFORMING TO CISPI 301 AND ASTM A 888 WITH NEOPRENE GASKET AND 300 SERIES STAINLESS STEEL CLAMPING DEVICE CONFORMING TO CISPI 310.
- A. DRAIN PIPING: HEAVY DUTY, SHIELDED. STAINLESS-STEEL COUPLINGS: WITH STAINLESS-STEEL SHIELD, STAINLESS-STEEL BANDS AND TIGHTENING DEVICES, AND ASTM C 564, RUBBER SLEEVE.
- B. VENT PIPING: STANDARD, SHIELDED. CISPI 310 STAINLESS-STEEL COUPLINGS: WITH STAINLESS-STEEL SHIELD, STAINLESS-STEEL BANDS AND TIGHTENING DEVICES, AND ASTM C 564, RUBBER SLEEVE.
- 2. COPPER DWV TUBE: ASTM B 306, DRAINAGE TUBE, DRAWN TEMPER. WITH ASME B16.23, CAST COPPER OR ASME B16.29, WROUGHT COPPER, SOLDER JOINT FITTINGS.

PLUMBING GENERAL NOTES

- CONTRACTOR SHALL CAREFULLY REVIEW THESE PLANS AND SPECIFICATIONS PRIOR TO BID. CONTRACTOR SHALL ALSO REVIEW PLANS AND SPECIFICATIONS OF OTHER RELATED TRADES (INCLUDING CIVIL, STRUCTURAL AND ELECTRICAL) PRIOR TO BID TO INSURE AN ACCURATE UNDERSTANDING OF EXACT SCOPE OF WORK. ANY ITEMS REQUIRING CLARIFICATION SHALL BE BROUGHT TO THE ATTENTION OF THE ARCHITECT IN SUFFICIENT TIME TO BE INCORPORATED INTO THE BID.
- CONTRACTOR SHALL VERIFY ALL EQUIPMENT MODEL NUMBERS, CAPACITIES, SIZES, VOLTAGES, AND ALL OTHER SCHEDULED INFORMATION WITH OTHER APPLICABLE TRADES AND WITH THE MANUFACTURER PRIOR TO INSTALLATION.
- CONTRACTOR SHALL VERIFY ALL LOCATIONS, SIZES, POC'S, INVERT ELEVATIONS, AND AVAILABILITY OF ALL EXISTING UTILITIES PRIOR TO INSTALLATION OF ANY MATERIAL OR EQUIPMENT.
- THESE DRAWINGS ARE ESSENTIALLY DIAGRAMMATIC AND ARE NOT INTENDED TO INDICATE ALL DETAILS AND NECESSARY OFFSETS OF PIPING. THE CONTRACTOR SHALL INSTALL MATERIAL AND EQUIPMENT IN A MANNER AS TO CONFORM TO STRUCTURE, AVOID OBSTRUCTIONS, PRESERVE HEADROOM, AND KEEP OPENINGS AND PASSAGEWAYS CLEAR. ALL INSTALLATIONS SHALL BE CONSISTENT WITH NORMALLY ACCEPTABLE INDUSTRY
- THE CONTRACTOR SHALL NOTIFY THE ARCHITECT IN WRITING OF ANY DISCREPANCIES OR CONFLICTS THAT WOULD EFFECT THE SYSTEM PERFORMANCE OR INCUR ADDITIONAL COSTS. THIS NOTIFICATION SHALL BE SUBMITTED PRIOR TO INSTALLATION OF THE ITEMS CONCERNED.
- NEW AND/OR EXISTING EQUIPMENT INDICATED ON THIS DRAWING IS SHOWN IN APPROXIMATE POSITION(S). CONTRACTOR SHALL FIELD VERIFY ALL EXISTING CONDITIONS INCLUDING EQUIPMENT LOCATIONS, POC'S AND STRUCTURAL MEMBERS PRIOR TO INSTALLATION. IN ALL CASES, ADEQUATE ACCESS (PER MANUFACTURERS RECOMMENDATIONS AND CODE COMPLIANCE) FOR MAINTENANCE AND REPLACEMENT OF EQUIPMENT SHALL BE
- ALL WORK SHALL BE DONE IN ACCORDANCE WITH ALL APPLICABLE CODES. NOTHING SHOWN ON THE PLANS OR STATED IN THE SPECIFICATIONS IS INTENDED TO INDICATE THAT THE INSTALLATIONS OR CONNECTIONS OF ANY ITEM OR DEVICE SHOULD BE DONE CONTRARY TO MANUFACTURERS INSTRUCTIONS AND ALL APPLICABLE CODES AND REGULATIONS.
- THE CONTRACTOR IS RESPONSIBLE TO INSURE THAT THE INSTALLATIONS AND CONNECTIONS OF ALL ITEMS AND DEVICES CONFORMS TO MANUFACTURERS INSTRUCTIONS AND TO ALL APPLICABLE CODES AND
- SUBSTITUTION OF PLUMBING EQUIPMENT WITH EFFICIENCIES LOWER THAN THOSE INDICATED ON THE PLANS MAY REQUIRE RE-CALCULATION OF TITLE 24 DOCUMENTS. IF THE CONTRACTOR CHOOSES TO UTILIZE SUCH EQUIPMENT, HE ASSUMES FULL RESPONSIBILITY FOR THE RE-CALCULATION AND JURISDICTIONAL APPROVAL OF TITLE 24 DOCUMENTS.
- O. IF THE CONTRACTORS' USE OF SUBSTITUTE MATERIALS, EQUIPMENT OR METHODS OF INSTALLATION REQUIRES ANY CHANGES IN OTHER TRADES WORK FROM THAT SHOWN ON THE DRAWINGS, THE EXTRA COST OF THE OTHER TRADES' WORK SHALL BE THE RESPONSIBILITY OF THE CONTRACTOR INITIATING THE SUBSTITUTION.
- SUBMITTALS: APPROVAL OF THE SUBMITTALS DOES NOT RELEASE THE CONTRACTOR FROM OBLIGATIONS TO FULLY COMPLY WITH ALL REQUIREMENTS OF THE CONSTRUCTION DOCUMENTS OR APPLICABLE CODE REGULATIONS.
- 2. ALL PLUMBING EQUIPMENT, MATERIAL, AND ALL CONNECTIONS THERETO SHALL BE INSTALLED COMPLETE PER MANUFACTURERS INSTRUCTIONS TO PROVIDE A COMPLETE AND FULLY OPERATIONAL SYSTEM.
- 13. PLUMBING EQUIPMENT SHALL BE CERTIFIED BY AND COMPLY WITH THE STATE OF CALIFORNIA ENERGY CONSERVATION STANDARDS (E.E.S.) SECTION 113. COMPLIANCE CERTIFICATES SHALL BE PROVIDED WITH EQUIPMENT SUBMITTALS.
- 14. ALL INSULATING MATERIALS INSTALLED MUST BE CERTIFIED BY CALIFORNIA ENERGY COMMISSION TO MEET C.E.C. ENERGY EFFICIENCY STANDARDS (E.E.S.) SECTION 118, 123 AND 124.
- 15. WATER HEATERS FOR DOMESTIC HOT WATER SHALL COMPLY WITH THE STATE OF CALIFORNIA ENERGY EFFICIENCY STANDARDS (E.E.S.) SECTION 113, AND 114.
- 16. SOIL, SEWER AND WASTE PIPING SHALL SLOPE AT 1/4" PER FOOT MINIMUM.
- 17. ALL PLUMBING SOLDER SHALL BE LEAD FREE.
- 8. ALL COMPONENTS OF POTABLE WATER SYSTEM, INCLUDING SHUT OFF VALVES, ANGLE STOPS, AND PLUMBING FIXTURE SHALL COMPLY WITH CALIFORNIA LAW AB 1953 AND SECTION 116875 OF THE CALIFORNIA HEALTH
- 19. PROVIDE CLEANOUTS EVERY 100' AND AT ANY CHANGE OF DIRECTION EXCEEDING 135 DEGREES.

SPECIAL NOTE TO PLUMBING CONTRACTOR

THE DESIGN OF THIS PROJECT WAS BASED UPON INFORMATION CONTAINED IN DRAWINGS PROVIDED BY THE PROPERTY OWNER. DISCREPANCIES BETWEEN INDICATED AND ACTUAL FIELD CONDITIONS MAY EXIST. IT IS A REQUIREMENT THAT THE CONTRACTOR VISIT THE SITE AND WALK THE JOB BEFORE SUBMITTING HIS BID AND SHALL MAKE ALL ALLOWANCES FOR PLAN/FIELD CONDITION DISCREPANCIES PRIOR TO SUBMITTING FOR BID. DURING THE CONSTRUCTION PROCESS IF A DISCREPANCY IS FOUND TO EXIST, THE CONTRACTOR SHALL DETERMINE A FIELD SOLUTION TO RESOLVE THE PROBLEM, AND THEN FORWARD THIS INFORMATION TO THE ARCHITECT FOR SUBMITTAL TO THE ENGINEER FOR APPROVAL. ADDITIONALLY, SEE PLUMBING GENERAL NOTES,

> 7360 CARROLL ROAD, STE. 100 SAN DIEGO, CA 92121 P: 858 578.3270 F: 858 578.3273

DEC PROJECT

33 + + × e

OBRARCHITECTURE, INC. ALL RIGHTS RESERVED DESIGNS THEREIN ARE THE PROPERTY OF OBRARCHITECTURE, INC. AND SHALL NOT BE COPIED, REPRODUCED, DISCLOSED TO OTHERS (THAN THE SPECIFIED PROJECT FOR WHICH THEY HAVE BEEN PREPARED, IN WHOLE OR IN PART, WITHOUT THE PRIOR WRITTEN AUTHORIZATION OF OBRARCHITECTURE, INC.

Y CULINARY CLA AND LEGE S Ш CUMI A SPRINC A ARTS A S AVENUE, LA IBING I 0

OL DISTRICT ASSROOM

03.26.2019

LMSV - 001

BID

REVISIONS

Sheet No.

LA LA 4200

P0.1

					FI	ΧTU	JRE CONNECTION SCHEDULE	
			MINIMUM	PIPE CONI	NECTION			
MARK	DESCRIPTION	CW ROUGH-IN	HW ROUGH-IN	WASTE ROUGH-IN	WASTE	VENT	MANUFACTURER / MODEL NUMBER	REMARKS
<u>S-1</u>	SINK	1/2"	1/2"	2"	2"	11/2"	ELKAY #, DOUBLE BOWL, 5-3/8" DEEP, TYPE 304 SS, UNDERMOUNT SINK. CHICAGO FAUCETS # 1100-E2805-5-369AB, 8" FIXED CENTER SWING SPOUT, 2-3/8" VANDAL PROOF HANDLES. 1.0 GPM FLOW WITH P-TRAP, STAINLESS STEEL SUPPLY HOSE AND LOOSE KEY STOPS.	SEE ARCHITECTURAL DRAWINGS FOR MOUNTING HEIGHT
<u>S-2</u>	SINK	1/2"	1/2"	2"	2"	1 ¹ /2"	ELKAY # 3C18X18-R-18X 16 GAUGE TYPE 304 SS, 2 COMP., SCULLERY SINK. KROWNE #17-109WL 8" CENTER WALL MOUNT PRE-RINSE W/ADD ON FAUCET.	
<u>FS-1</u>	FLOOR SINK	-	-	SEE FLOOR PLANS	SEE FLOOR PLANS	SEE FLOOR PLANS	ZURN # Z1901, FLOOR SINK, DEEP CAST IRON BODY AND SQUARE SLOTTED LIGHT DUTY GRATE, WITH WHITE ACID RESISTING PORCELAIN ENAMEL INTERIOR AND TOP, COMPLETE WITH WHITE ABS ANTI-SPLASH INTERIOR BOTTOM DOME STRAINER.	SEE FLOOR PLANS FOR EXACT OUTLET SIZE

						CIR	RCU	ILA ⁻	TION	PUMPS		
UNIT NO.	MANUFACTURER & MODEL NO.	SERVICE	LOCATION	TYPE	PUMP GPM	N CAPACITY PUMP HEAD (FT)		ELEC. DA MOTOR RPM	V/PH/HZ	OVERALL DIMENSION (LxWxH)	OPR. WT. (LBS)	REMARKS
CP 1	BELL & GOSSETT # NBF-9U OR EQUAL	DOMESTIC	CLASSROOM	IN-LINE	5	11	1/16	2800	115/1/60	6" x 5" x 4"	9.3	PROVIDE AQUASTAT CONTROLLER TIMER KIT TO ACTIVATE PUMP WHEN HOT WATER RETURN REACHES 110°F AND DEACTIVATE PUMP AT 120°F

		WATER HEATER										
UNIT NO.	MANUFACTURER & MODEL NO.	SERVICE	LOCATION	TYPE	STORAGE (GALLONS)	UNIT CAPA RECOVERY GPH		SYSTEM OUTLET TEMP. (*F)	V/PH/HZ	OVERALL DIMENSIONS (DIAxH)	OPER. WT. (LBS)	REMARKS
WH 1	BRADFORD WHITE LE120L3-3	DOMESTIC	-	ELECTRIC	19	13	80	120	277/1/60	18" x 24-3/4"	220	2500/2500 NON SIMULTANEOUS

				EXPA	nsion ⁻	TANK
UNIT NO.	MANUFACTURER & MODEL NO.	DESCRIPTION	SERVICE	LOCATION	OVERALL DIMENSIONS (LxWxH)	REMARKS
ET 1	AMTROL #ST-5	EXPANSION TANK	DOMESTIC	-	8" X 8" X 12-5/8"	2 GALLON EXPANSION TANK, NON-ASME RATED, FACTORY PRE-CHARGED BLADDER.

			THER	RMOS	STATIC MIXING VALVE
MARK	DESCRIPTION	MANUFACTURER & MODEL NUMBER	LOCATION	OPER. WT. (LBS)	REMARKS
(TMV)	THERMOSTATIC MIXING VALVE (DOMESTIC WATER)	BRADLEY #S59-4007	SCULLERY SINK	-	LEAD FREE POINT OF USE THERMOSTATIC MIXING VALVE, SET AT 120°F, 2.5 GPM AT 5 PSI DROP.



3817 Ray Street San Diego, e info@obrarchitecture.c w obrarchitecture.com t 619.564.7586 f 619.568.3636

OBRARCHITECTURE, INC. ALL RIGHTS RESERVED.
THE ABOVE DRAWINGS, IDEAS, AND EMBODIED
DESIGNS THEREIN ARE THE PROPERTY OF
OBRARCHITECTURE, INC. AND SHALL NOT BE
COPIED, REPRODUCED, DISCLOSED TO OTHERS OR
USED IN CONNECTION WITH ANY WORK OTHER
THAN THE SPECIFIED PROJECT FOR WHICH THEY
HAVE BEEN PREPARED, IN WHOLE OR IN PART,
WITHOUT THE PRIOR WRITTEN AUTHORIZATION
OF OBRARCHITECTURE, INC.

LA MESA SPRING VALLEY UNIFIED SCHOOL DISTRICT
LA MESA ARTS ACADEMY CULINARY CLASSROOM
4200 PARKS AVENUE, LA MESA, CA 91941
PLUMBING NOTES AND LEGEND

BID DOCUMENT SET


03.26.2019 Date Issued

REVISIONS

LMSV - 001 Job No. Sheet No.

P0.2



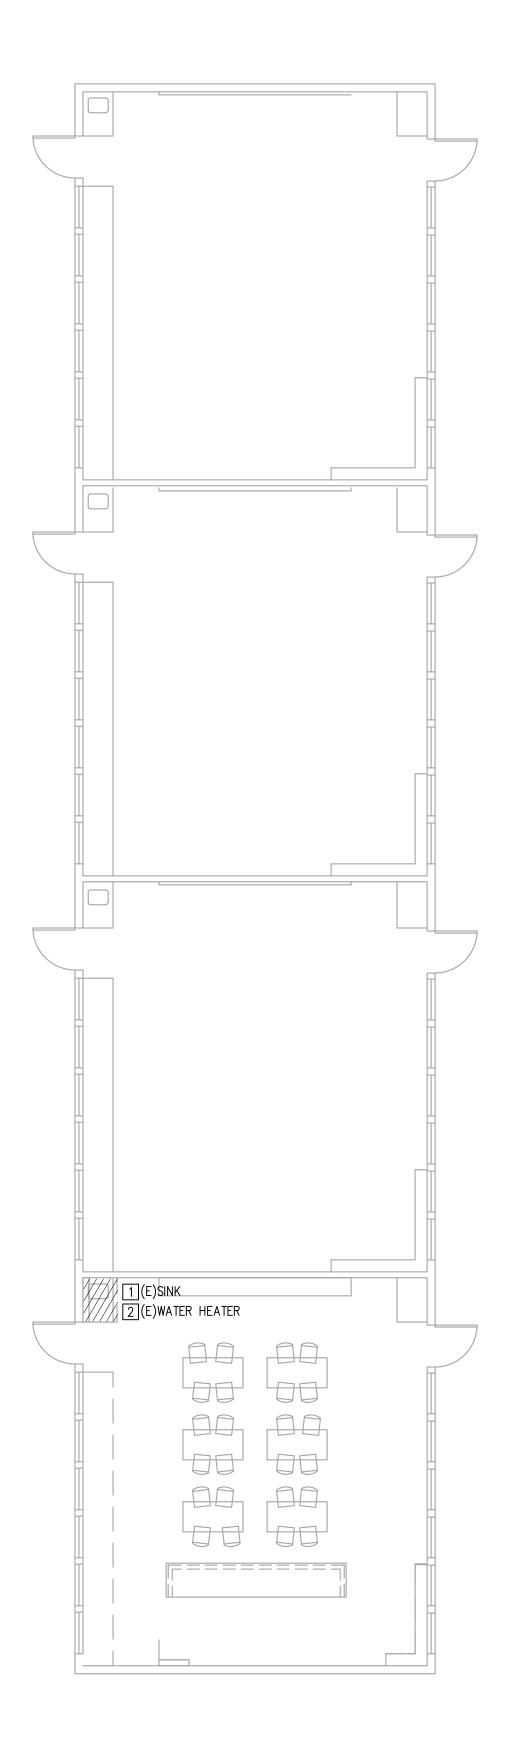

DEMOLITION NOTES

- 1 REMOVE EXISTING SINK AND ALL APPURTENANCES.
- 2 REMOVE EXISTING WATER HEATER AND ALL APPURTENANCES.

3817 Ray e info@ w obrarc t 619.56 f 619.56

OBRARCHITECTURE, INC. ALL RIGHTS RESERVED. THE ABOVE DRAWINGS, IDEAS, AND EMBODIED DESIGNS THEREIN ARE THE PROPERTY OF OBRARCHITECTURE, INC. AND SHALL NOT BE COPIED, REPRODUCED, DISCLOSED TO OTHERS OR USED IN CONNECTION WITH ANY WORK OTHER THAN THE SPECIFIED PROJECT FOR WHICH THEY HAVE BEEN PREPARED, IN WHOLE OR IN PART, WITHOUT THE PRIOR WRITTEN AUTHORIZATION OF OBRARCHITECTURE, INC.

LA MESA SPRING VALLEY UNIFIED SCHOOL DISTRICT
LA MESA ARTS ACADEMY CULINARY CLASSROOM
4200 PARKS AVENUE, LA MESA, CA 91941
PLUMBING DEMOLITION PLAN

SET

DOCUMENT


BID 03.26.2019

Sheet No. P1.1

LMSV - 001


SCALE 1/8" = 1'-0"

7360 CARROLL ROAD, STE. 100 SAN DIEGO, CA 92121 P: 858 578.3270 F: 858 578.3273

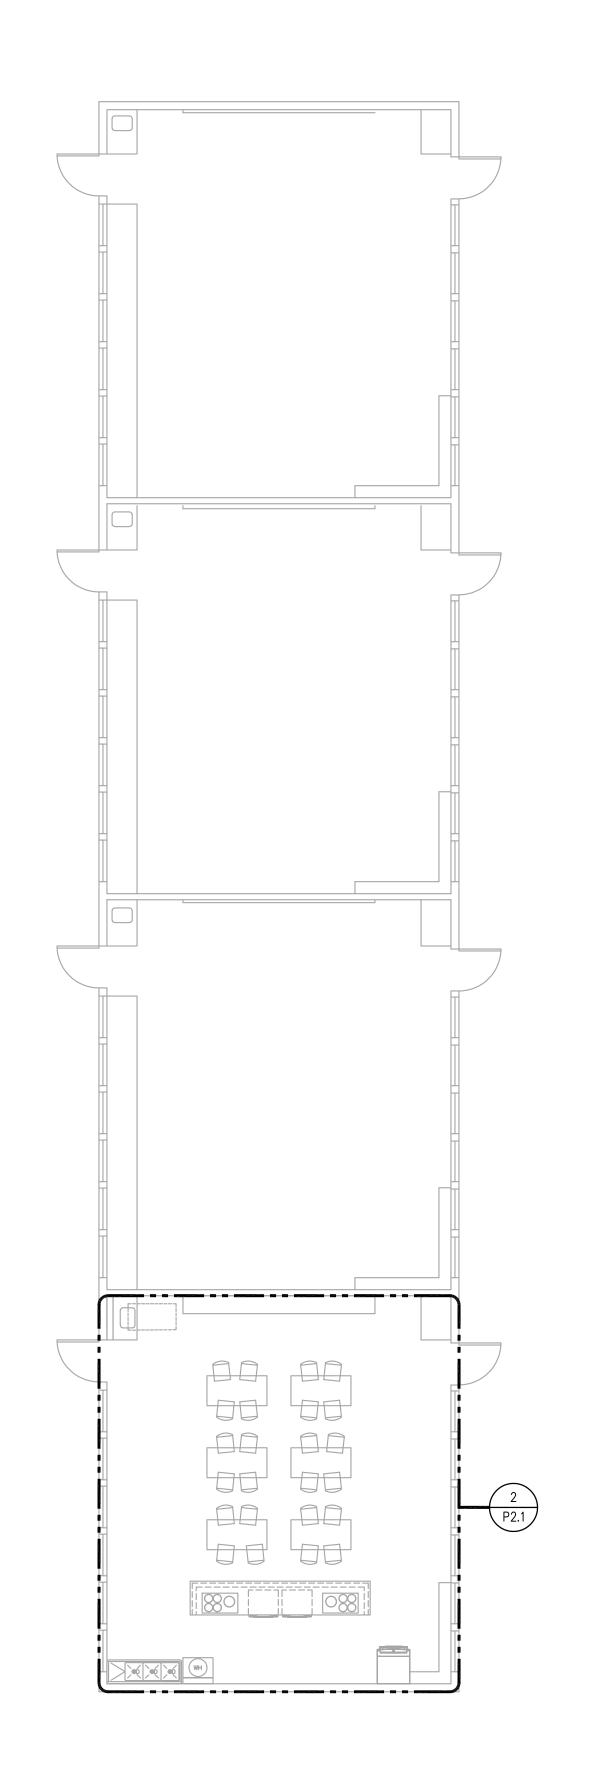

NEW WORK NOTES

- 1) 2" VENT UP FROM BELOW FLOOR. ROUTE VENT UP TIGHT TO WALL AND TERMINATE THROUGH ROOF. VENT TERMINATION ON ROOF SHALL HAVE A MINIMUM OF 10' CLEARANCE FROM ANY OUTSIDE AIR INTAKE.
- (2) INSTALL NEW SINK AND FAUCET. CONNECT TO EXISTING UTILITY ROUGH IN. CONTRACTOR SHALL ADJUST EXISTING ROUGH IN AS REQUIRED TO ACCOMMODATE NEW FIXTURE
- 3 CONNECT TO EXISTING SANITARY WASTE PIPE BELOW GRADE. CONTRACTOR SHALL FIELD VERIFY EXISTING SIZE AND LOCATION PRIOR TO INSTALLATION.
- (4) CONNECT TO EXISTING CW ABOVE CEILING. CONTRACTOR SHALL FIELD VERIFY EXISTING SIZE AND LOCATION PRIOR TO INSTALLATION.
- (5) 3/4" CW AND HW DOWN TIGHT TO WALL. ROUTE PIPING BELOW SINK TO SUPPLY STOP VALVES.
- 6 3/4" CW & HW DOWN TO WATER HEATER.
- 7) ROUTE AND TERMINATE FULL SIZE T&P VALVE FROM WATER HEATER TO FLOOR SINK. PROVIDE AIR GAP AT TERMINATION.
- (8) 3/4" HW DOWN TIGHT TO WALL AND THROUGH EXISTING COUNTER TOP. ROUTE PIPE BELOW SINK AND PROVIDE SUPPLY STOP VALVE UNDER COUNTER.

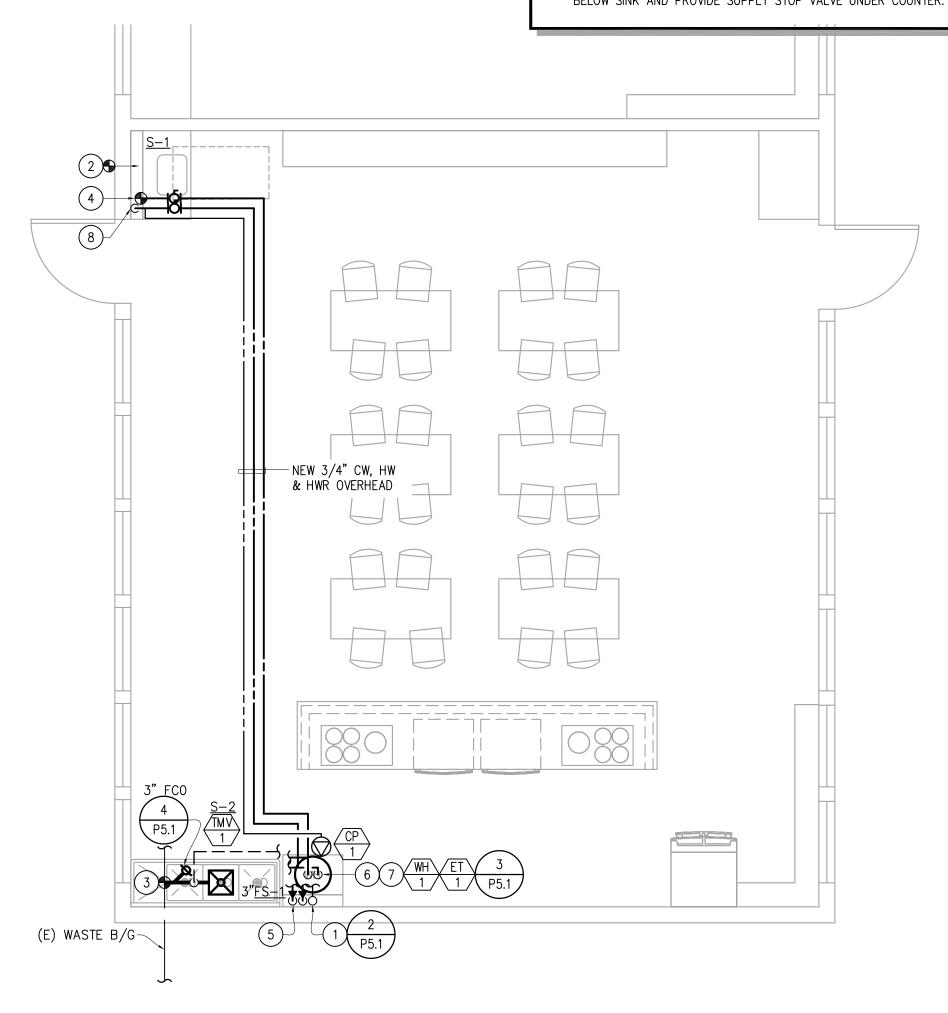

38 f t ≤ e

OBRARCHITECTURE, INC. ALL RIGHTS RESERVED. DESIGNS THEREIN ARE THE PROPERTY OF OBRARCHITECTURE, INC. AND SHALL NOT BE COPIED, REPRODUCED, DISCLOSED TO OTHERS OF USED IN CONNECTION WITH ANY WORK OTHER THAN THE SPECIFIED PROJECT FOR WHICH THEY HAVE BEEN PREPARED, IN WHOLE OR IN PART,

WITHOUT THE PRIOR WRITTEN AUTHORIZATION OF OBRARCHITECTURE, INC.

LA MESA SPRING VALLEY UNIFIED SCHOOL DISTRICT
LA MESA ARTS ACADEMY CULINARY CLASSROOM
4200 PARKS AVENUE, LA MESA, CA 91941
PLUMBING NEW WORK PLAN


DOCUMENT

03.26.2019

LMSV - 001 Sheet No.

P2.1



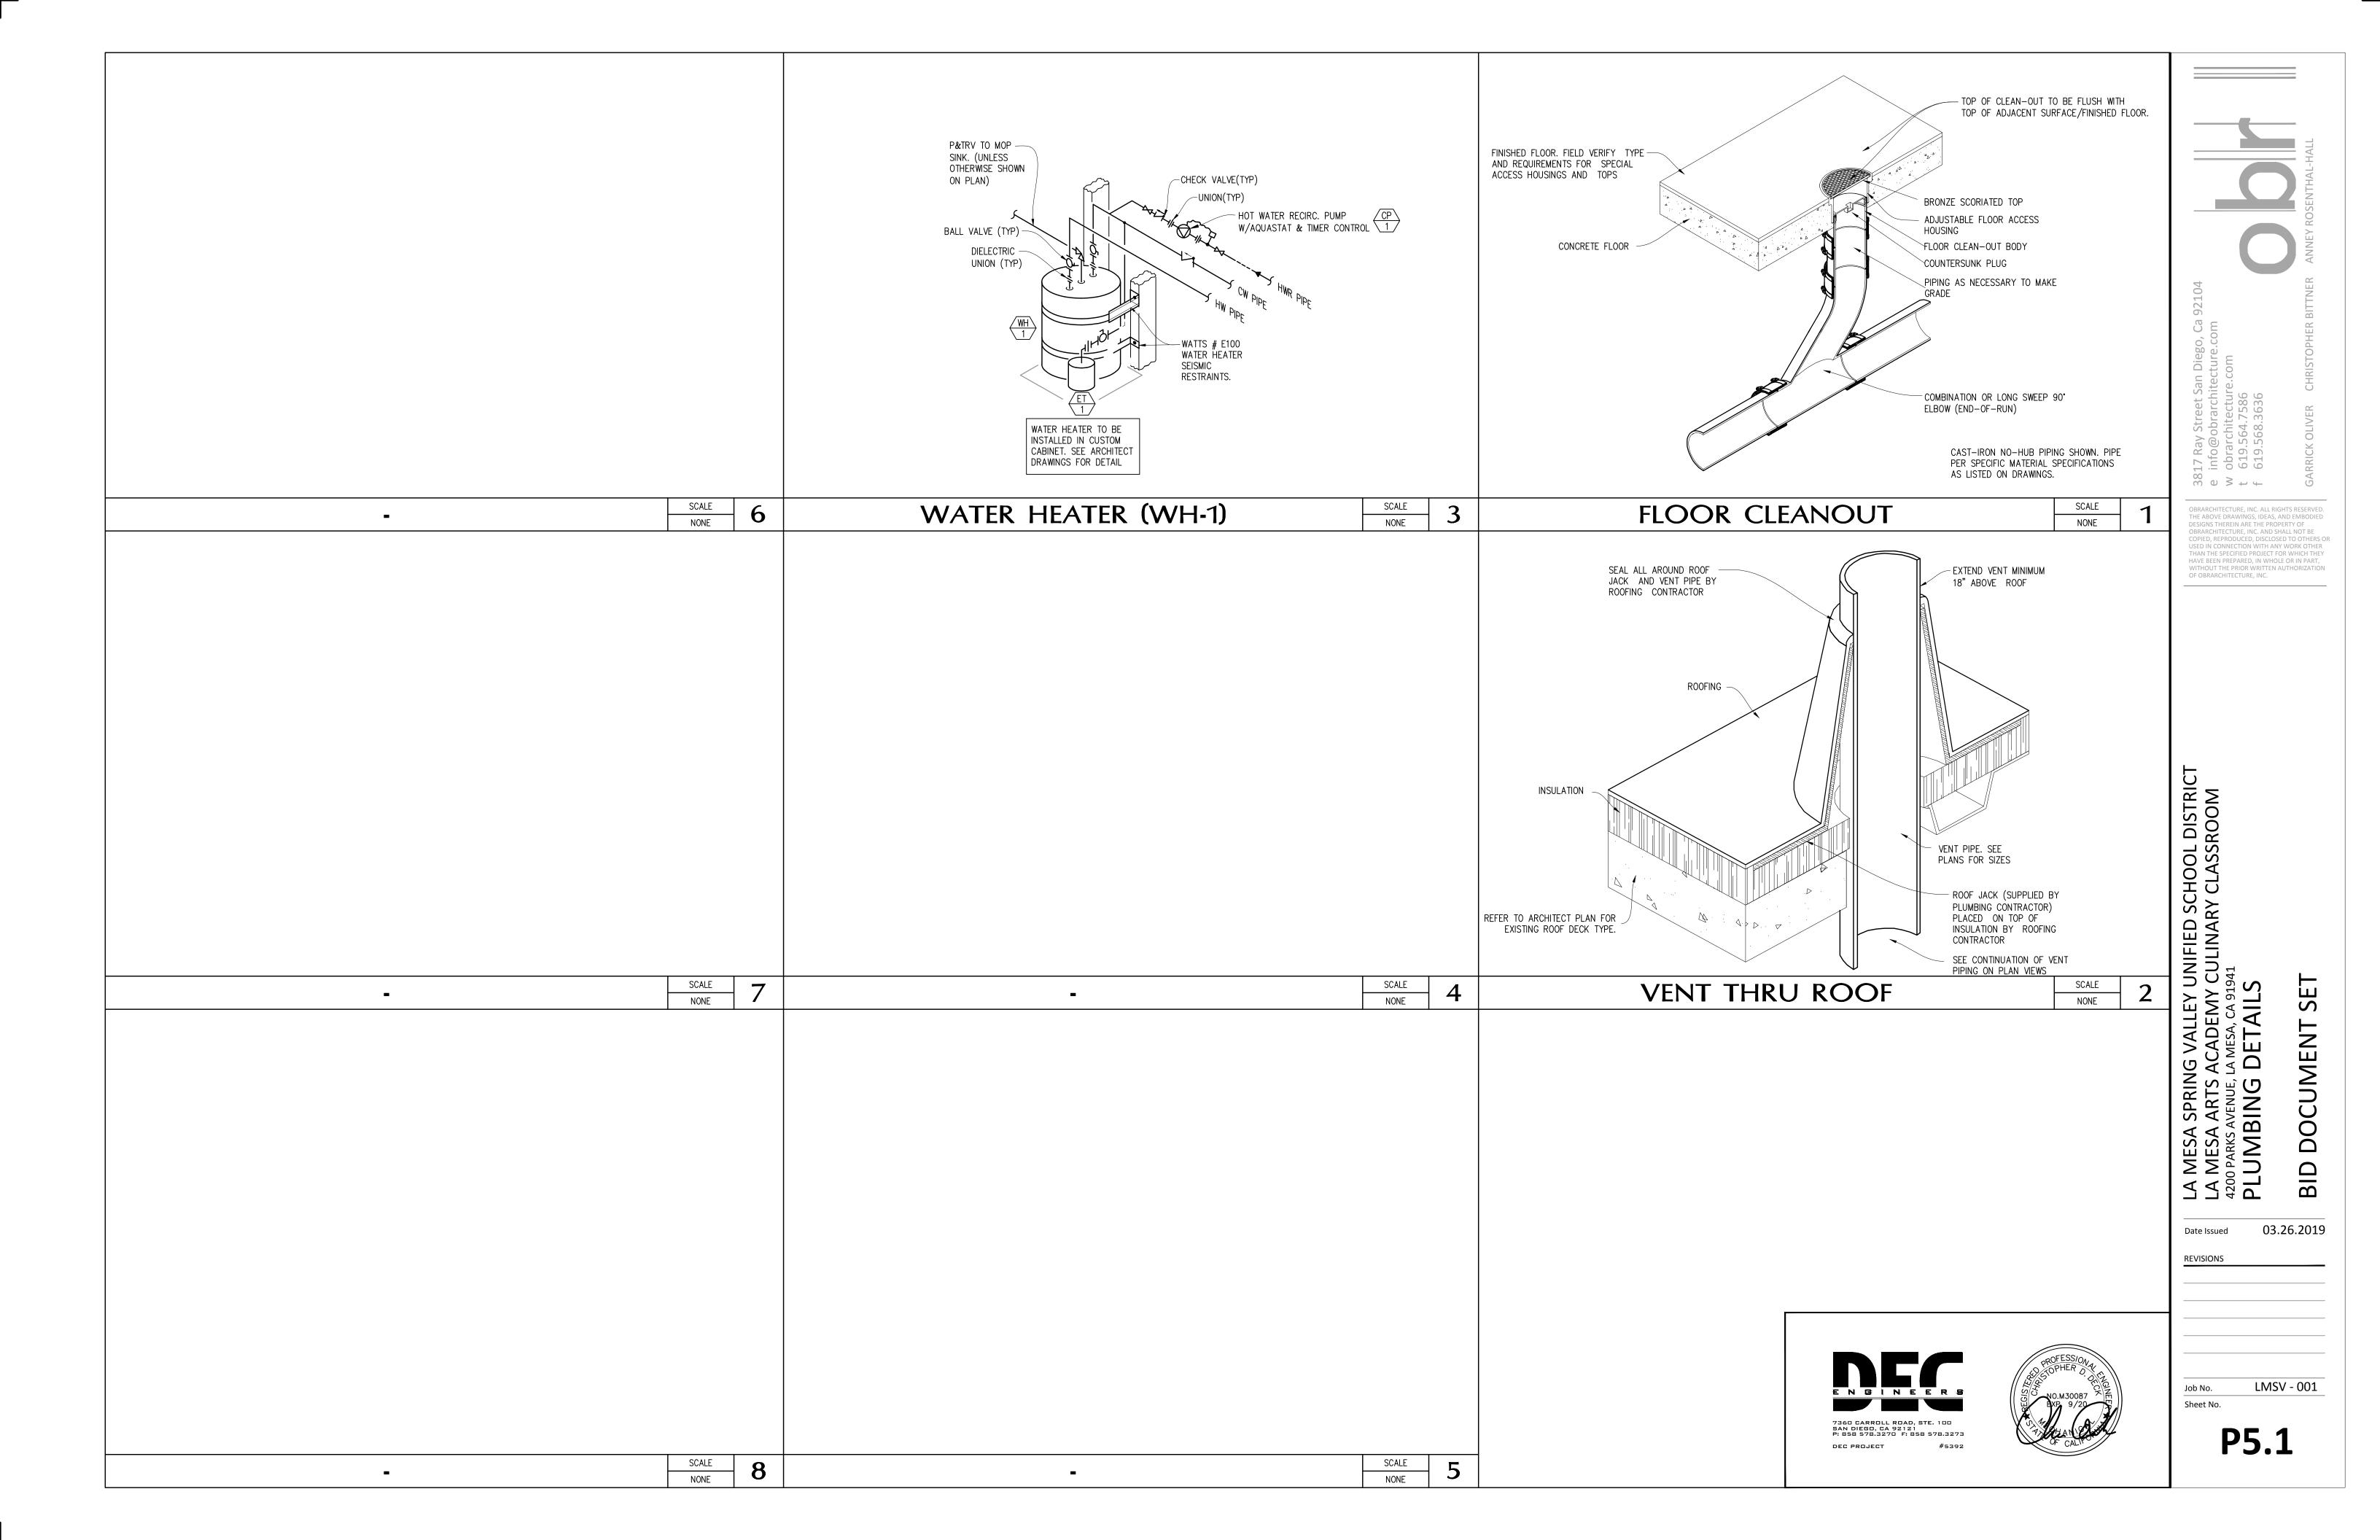

FIFCTRICAL IFGENID

	EL	LECTRICAL LEGI	END
GENERAL	ABBRE	VIATIONS	GENERAL NOTES
POWER POWER PANEL CIRCUIT BREAKER NUMBER OF POLES AMPS FRAME AMPS TRIP KAIC RATING ELECTRICAL METER GROUND TRANSFORMER PANELBOARD, 480Y/277V, SURFACE MOUNTED PANELBOARD, 208Y/120V, FLUSH MOUNTED	A AMPERE AF AF. ABOVE FINISHED FLOOR AMP TRIP BCU BLDG BUILDING C CONDUCTOR, CONDUIT CIRCUIT BREAKER CIRCUIT CW COLD WATER D DEDICATED E ELECT ELECTRICAL GFI GROUND FAULT INTERRUPTER GROUND KAIC KILO AMPERE INTERRUPTING CAPACIKA KILOVOLT-AMPERE	MIN MINIMUM P POLE PHASE. FURNISH, INSTALL, CONNECT AND TEST SDG&E SAN DIEGO GAS AND ELECTRIC TYP TYPICAL UON UNLESS OTHERWISE NOTED UNDERGROUND PULL SECTION V VOLTAGE W WIRE WP WEATHERPROOF WITH	GENERAL NOTES 1. ELECTRICAL WORK SHALL COMPLY WITH THE LATEST EDITION OF THE CALIFORNIA ELECTRICAL CODE (CEC) AND THE AUTHORITIES HAVING JURISDICTION. 2. THE CONTRACTOR SHALL EXAMINE THE ARCHITECTURAL, MECHANICAL, AND OTHER RELEVANT SHEETS OF THE PLANS AND WISIT THE SITE OF THE WORK, TO FAMIL BIRD HERE IS WITH EXSISTING GONDITIONS AND ASCERTAIN THE WORK ENTAILED IN THIS CONTRACT BY SUBMITTING A BID FOR THE WORK, THE CONTRACTOR SHALL BE DEEMED TO HAVE MADE SUCH EXAMINATION, AND THAT HE IS FAMILIAR WITH AND ACCEPTS THE CONDITIONS OF THE JOB AND SITE. 3. UNLESS OTHERWISE NOTED OR SHOWN, THESE DRAWINGS AND SPECIFICATIONS DO NOT INDICATE METHODS OF CONSTRUCTION, THE CONTRACTOR SHALL SUPERVISE AND DIRECT THE WORK AND BE SOLELY RESPONSIBLE FOR ALL CONSTRUCTION MEANS, METHODS, TECHNIQUES SEQUENCES AND PROCEDURES. 4. CONDUIT RUNS ARE SHOWN DIAGRAMMATICALLY. CONTRACTOR TO DETERMINE THE EXACT LOCATION IN THE FIELD. 5. ALL EQUIPMENT SUCH AS ENCLOSURES, METALLIC CONDUITS, JUNCTION BOXES, FIXTURES, AND ALL OTHER APPARATUS SHALL BE PERMANENTLY AND SEFFECTIVELY (SOCIUMBE). 6. ALL MATERIAL AND EQUIPMENT INDICATED ON PLANS ARE NEW UNLESS SPECIFICALLY INDICATED OTHERWISE. IN GENERAL, DARKER OR HEAVY LINES INDICATE NEW WORK.
 DUPLEX CONVENIENCE OUTLET, +18" AFF UON JUNCTION BOX, 4" SQUARE UON 			
\$ MOTOR RATED TOGGLE SWITCH, SINGLE POLE			Sheet Number Sheet Title E.001 ELECTRICAL SYMBOLS, ABBREVIATIONS & LEGEND E.100 ELECTRICAL SITE PLAN E.200 ELECTRICAL POWER PLAN E.301 SINGLE LINE DIAGRAM & PANEL SCHEDULES E.400 ELECTRICAL DETAILS
ELECTRICAL FEEDERS	RACEW	AYS	
— — — UNDERGROUND ELECTRICAL CONDUIT.	MULTI OUTLET SURFACE	MOUNTED RACEWAY.	PROFESS/ON

WIRING OR CONDUIT CONCEALED IN WALL OR CEILING.

PANELBOARD DESIGNATION AND CIRCUIT NUMBER(S).

1ELA-1

CONDUIT HOMERUN TO PANELBOARD. TEXT INDICATES ELECTRICAL



3817 Ray Stree info@obra w obrarchite t 619.564.7 f 619.568.3

OBRARCHITECTURE, INC. ALL RIGHTS RESERVED. THE ABOVE DRAWINGS, IDEAS, AND EMBODIED DESIGNS THEREIN ARE THE PROPERTY OF OBRARCHITECTURE, INC. AND SHALL NOT BE COPIED, REPRODUCED, DISCLOSED TO OTHERS OR USED IN CONNECTION WITH ANY WORK OTHER THAN THE SPECIFIED PROJECT FOR WHICH THEY HAVE BEEN PREPARED, IN WHOLE OR IN PART, WITHOUT THE PRIOR WRITTEN AUTHORIZATION OF OBRARCHITECTURE, INC.

ONS &

SET


BID DOCUMENT

LA MESA SPRING VALLEY UNIFIED SCHOOL DISTRICT LA MESA ARTS ACADEMY CULINARY CLASSROOM 4200 Parks avenue, la mesa, ca 91941 SYMBOLS, ELECTRICAL

03.26.2019

LMSV - 001 Sheet No.

E.001

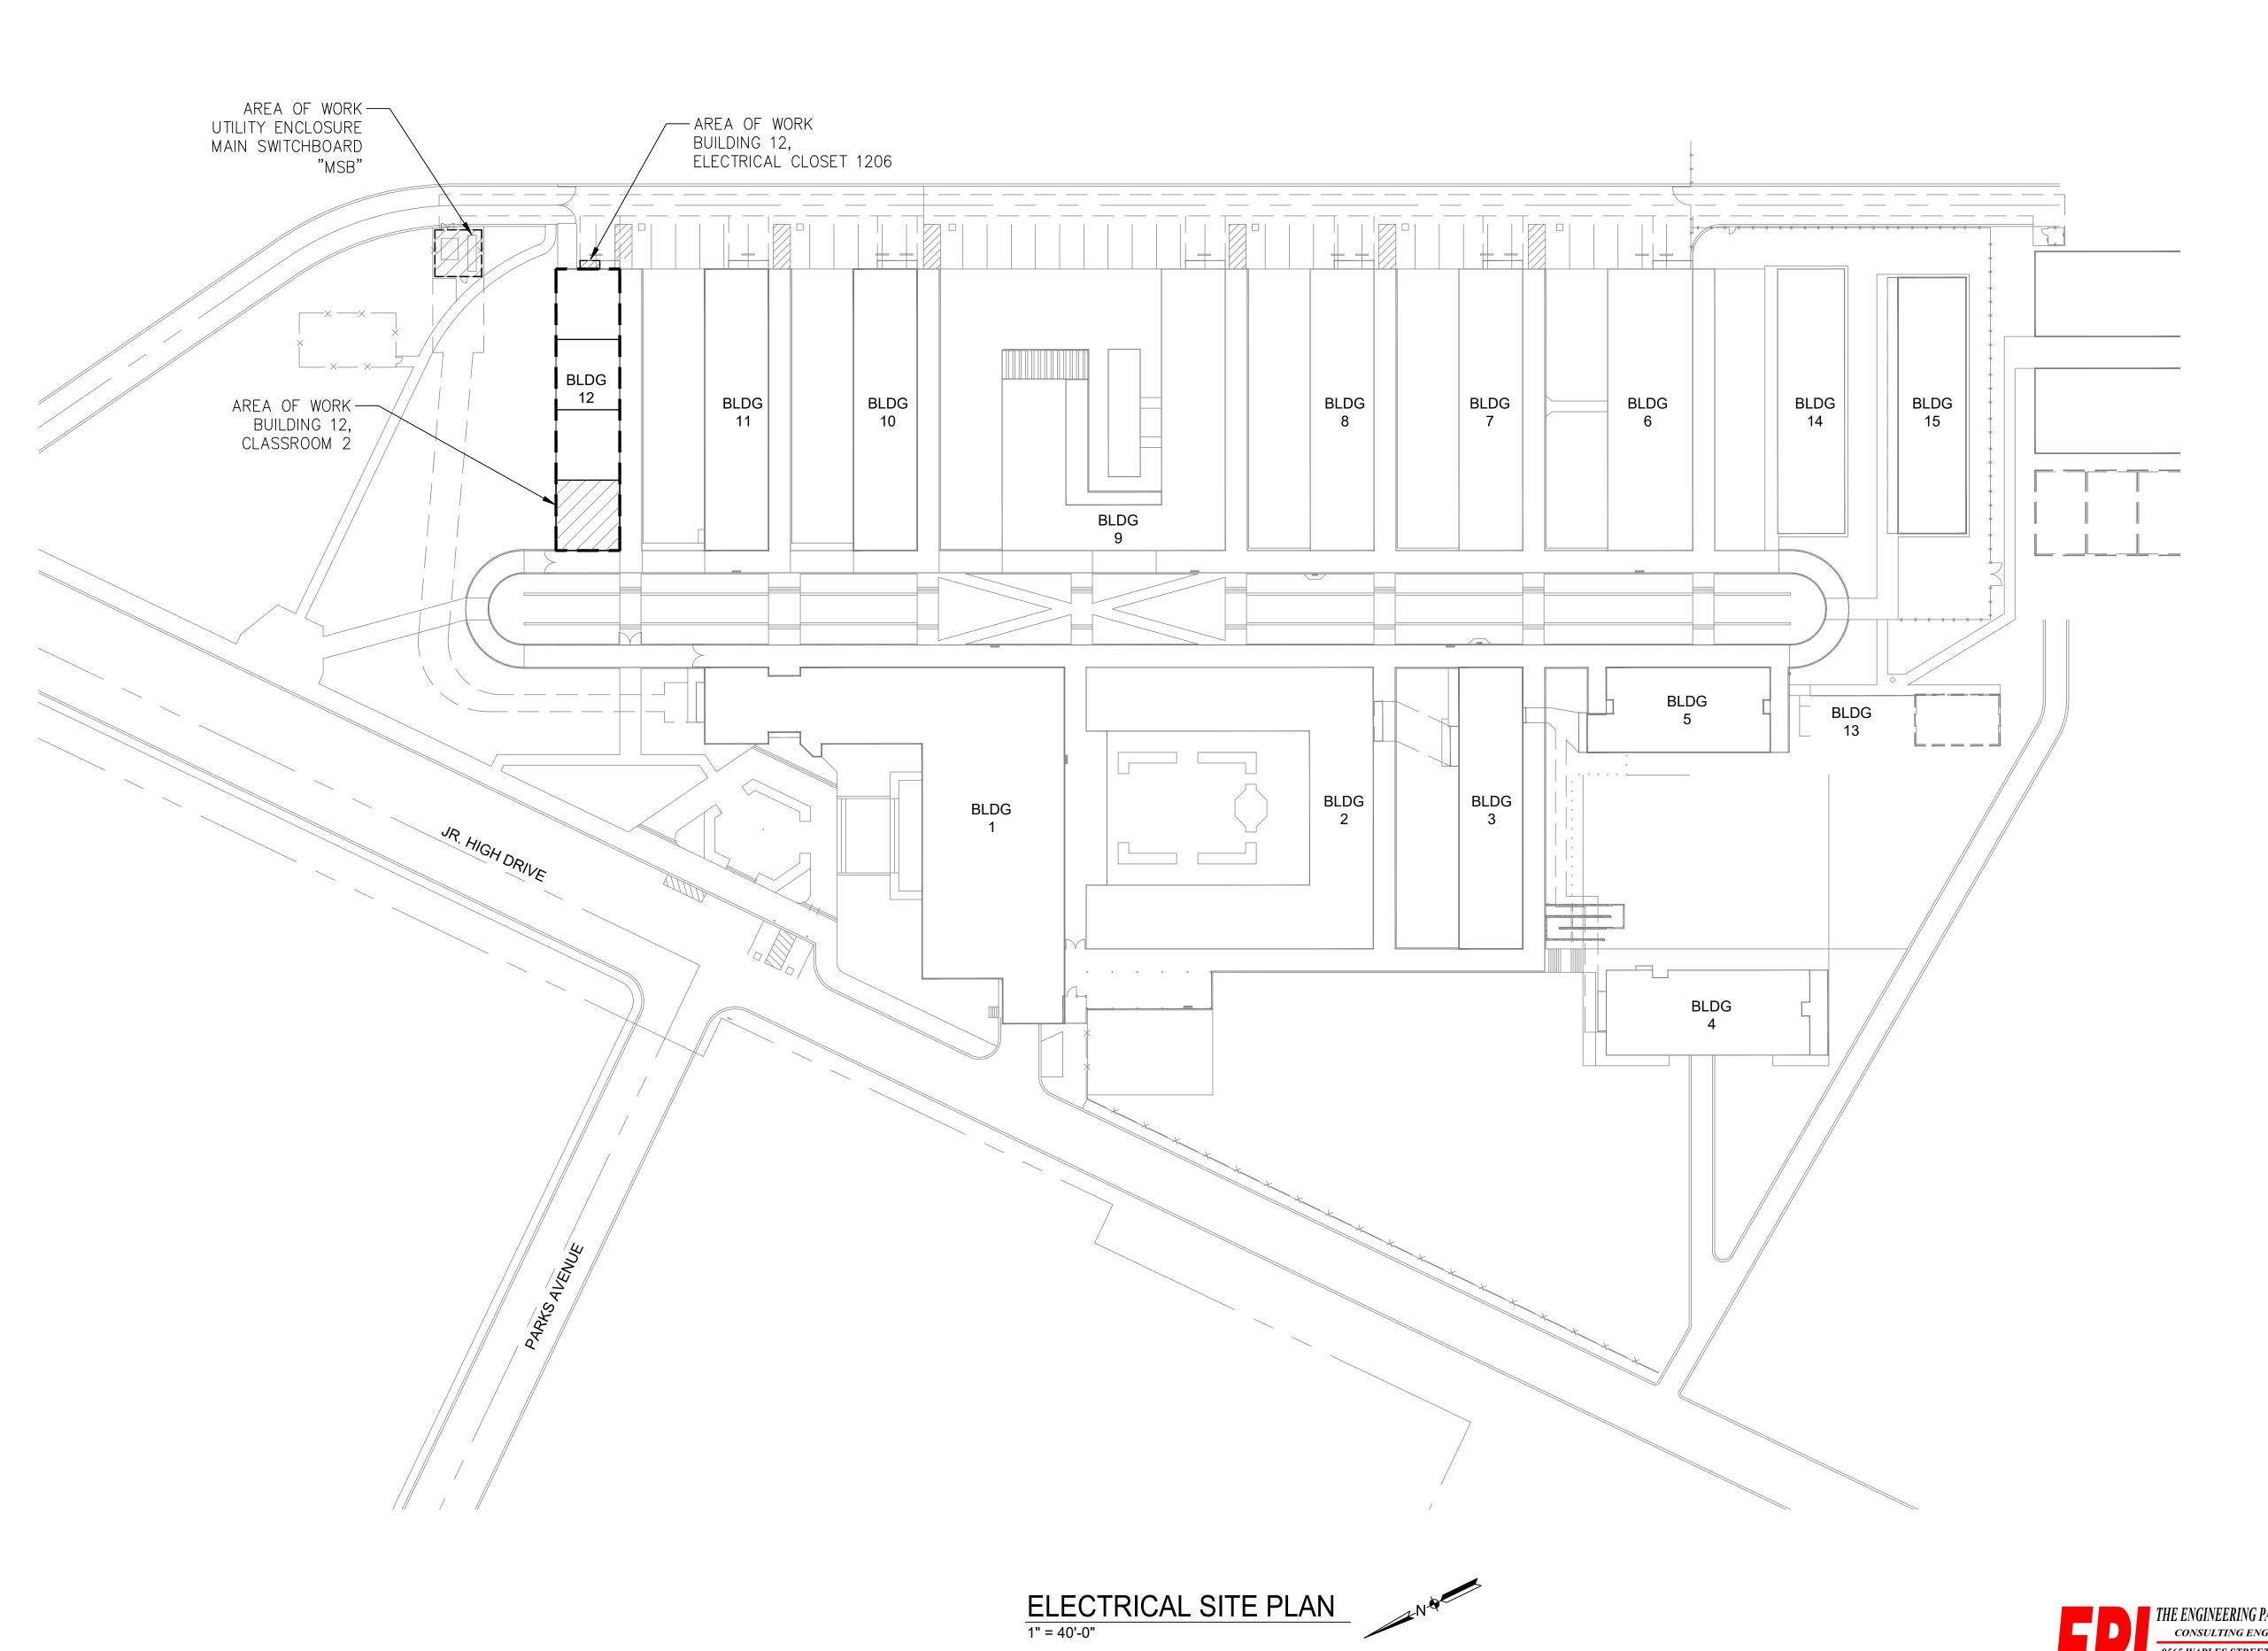

38 + + € e 38

OBRARCHITECTURE, INC. ALL RIGHTS RESERVED.
THE ABOVE DRAWINGS, IDEAS, AND EMBODIED
DESIGNS THEREIN ARE THE PROPERTY OF
OBRARCHITECTURE, INC. AND SHALL NOT BE
COPIED, REPRODUCED, DISCLOSED TO OTHERS OR
USED IN CONNECTION WITH ANY WORK OTHER
THAN THE SPECIFIED PROJECT FOR WHICH THEY
HAVE BEEN PREPARED, IN WHOLE OR IN PART,
WITHOUT THE PRIOR WRITTEN AUTHORIZATION
OF OBRARCHITECTURE, INC.


LA MESA SPRING VALLEY UNIFIED SCHOOL DISTRICT LA MESA ARTS ACADEMY CULINARY CLASSROOM 4200 Parks avenue, la mesa, ca 91941 ELECTRICAL SITE PLAN

BID DOCUMENT SET 03.26.2019

LMSV - 001 Job No. Sheet No.

E.100

9565 WAPLES STREET, SUITE 100 SAN DIEGO, CA 92121 (858) 824-1761 FAX (858) 824-1768 EPI PROJECT #140-77E 1" = 40'-0"

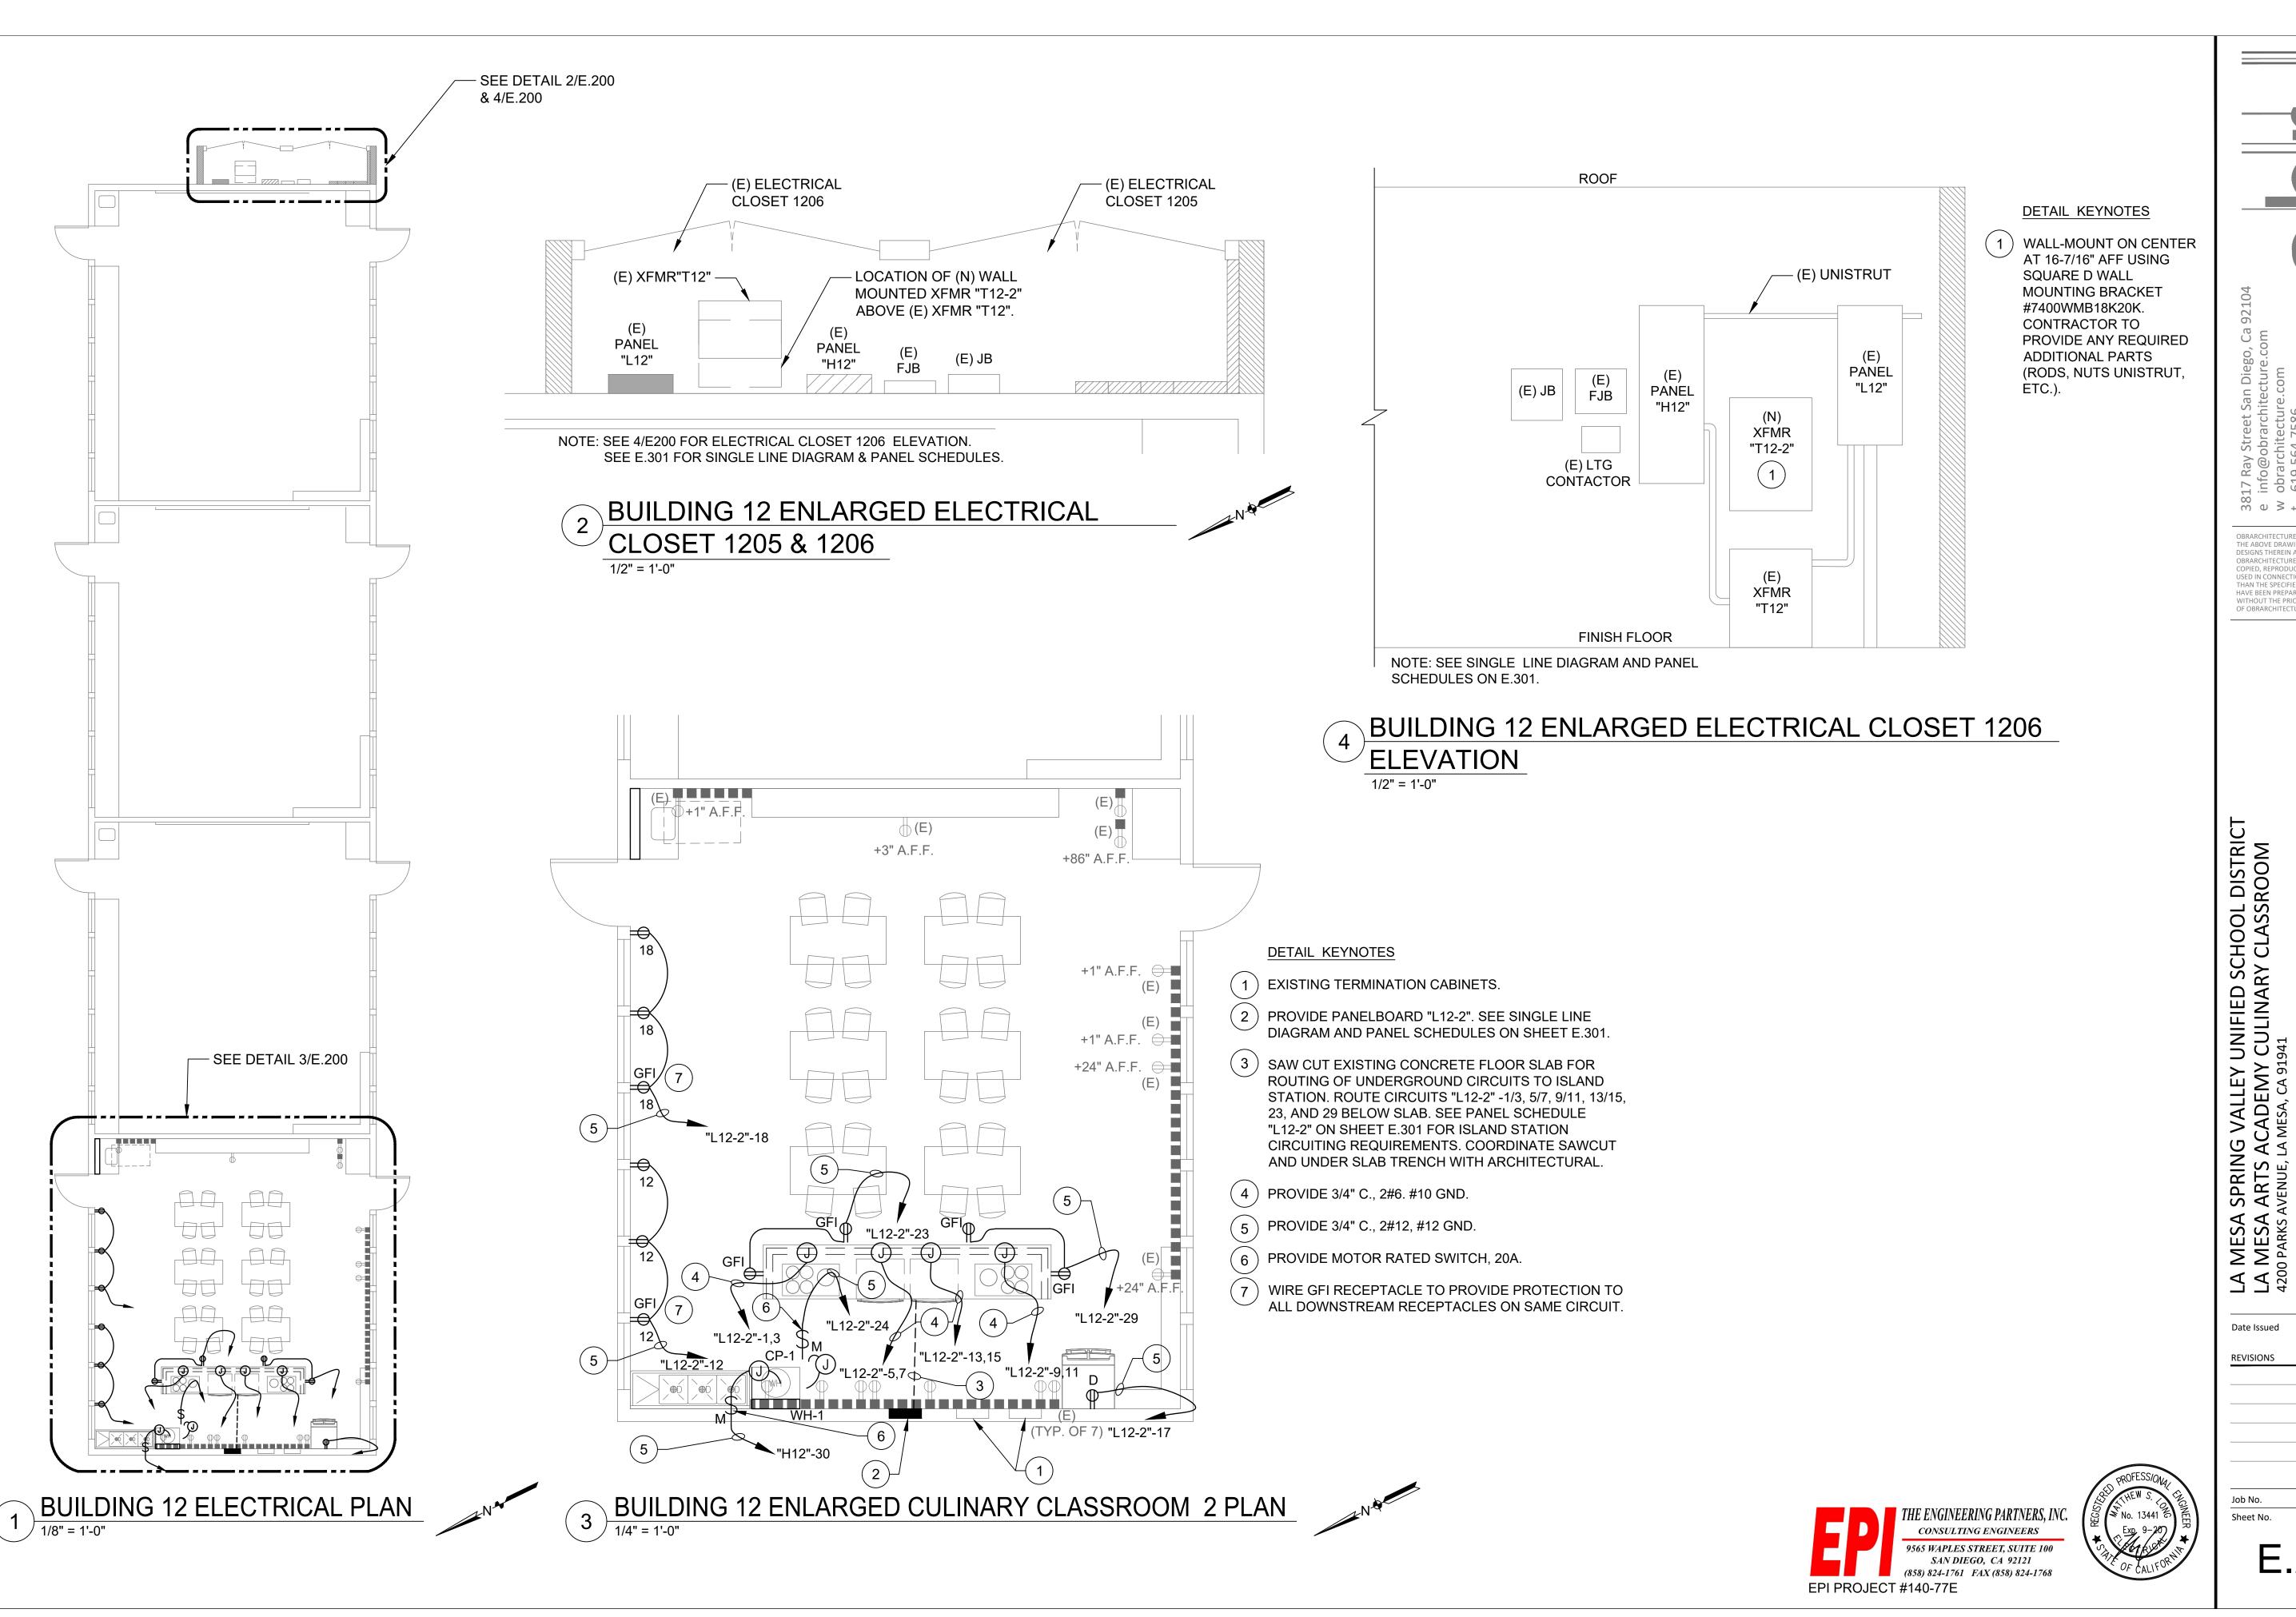

38 + 1 × e

OBRARCHITECTURE, INC. ALL RIGHTS RESERVED. THE ABOVE DRAWINGS, IDEAS, AND EMBODIED

DESIGNS THEREIN ARE THE PROPERTY OF DBRARCHITECTURE, INC. AND SHALL NOT BE THAN THE SPECIFIED PROJECT FOR WHICH THEY
HAVE BEEN PREPARED, IN WHOLE OR IN PART, WITHOUT THE PRIOR WRITTEN AUTHORIZATION OF OBRARCHITECTURE, INC.

> POWER ELECTRICAL


S

BID 03.26.2019

REVISIONS

LMSV - 001

E.200

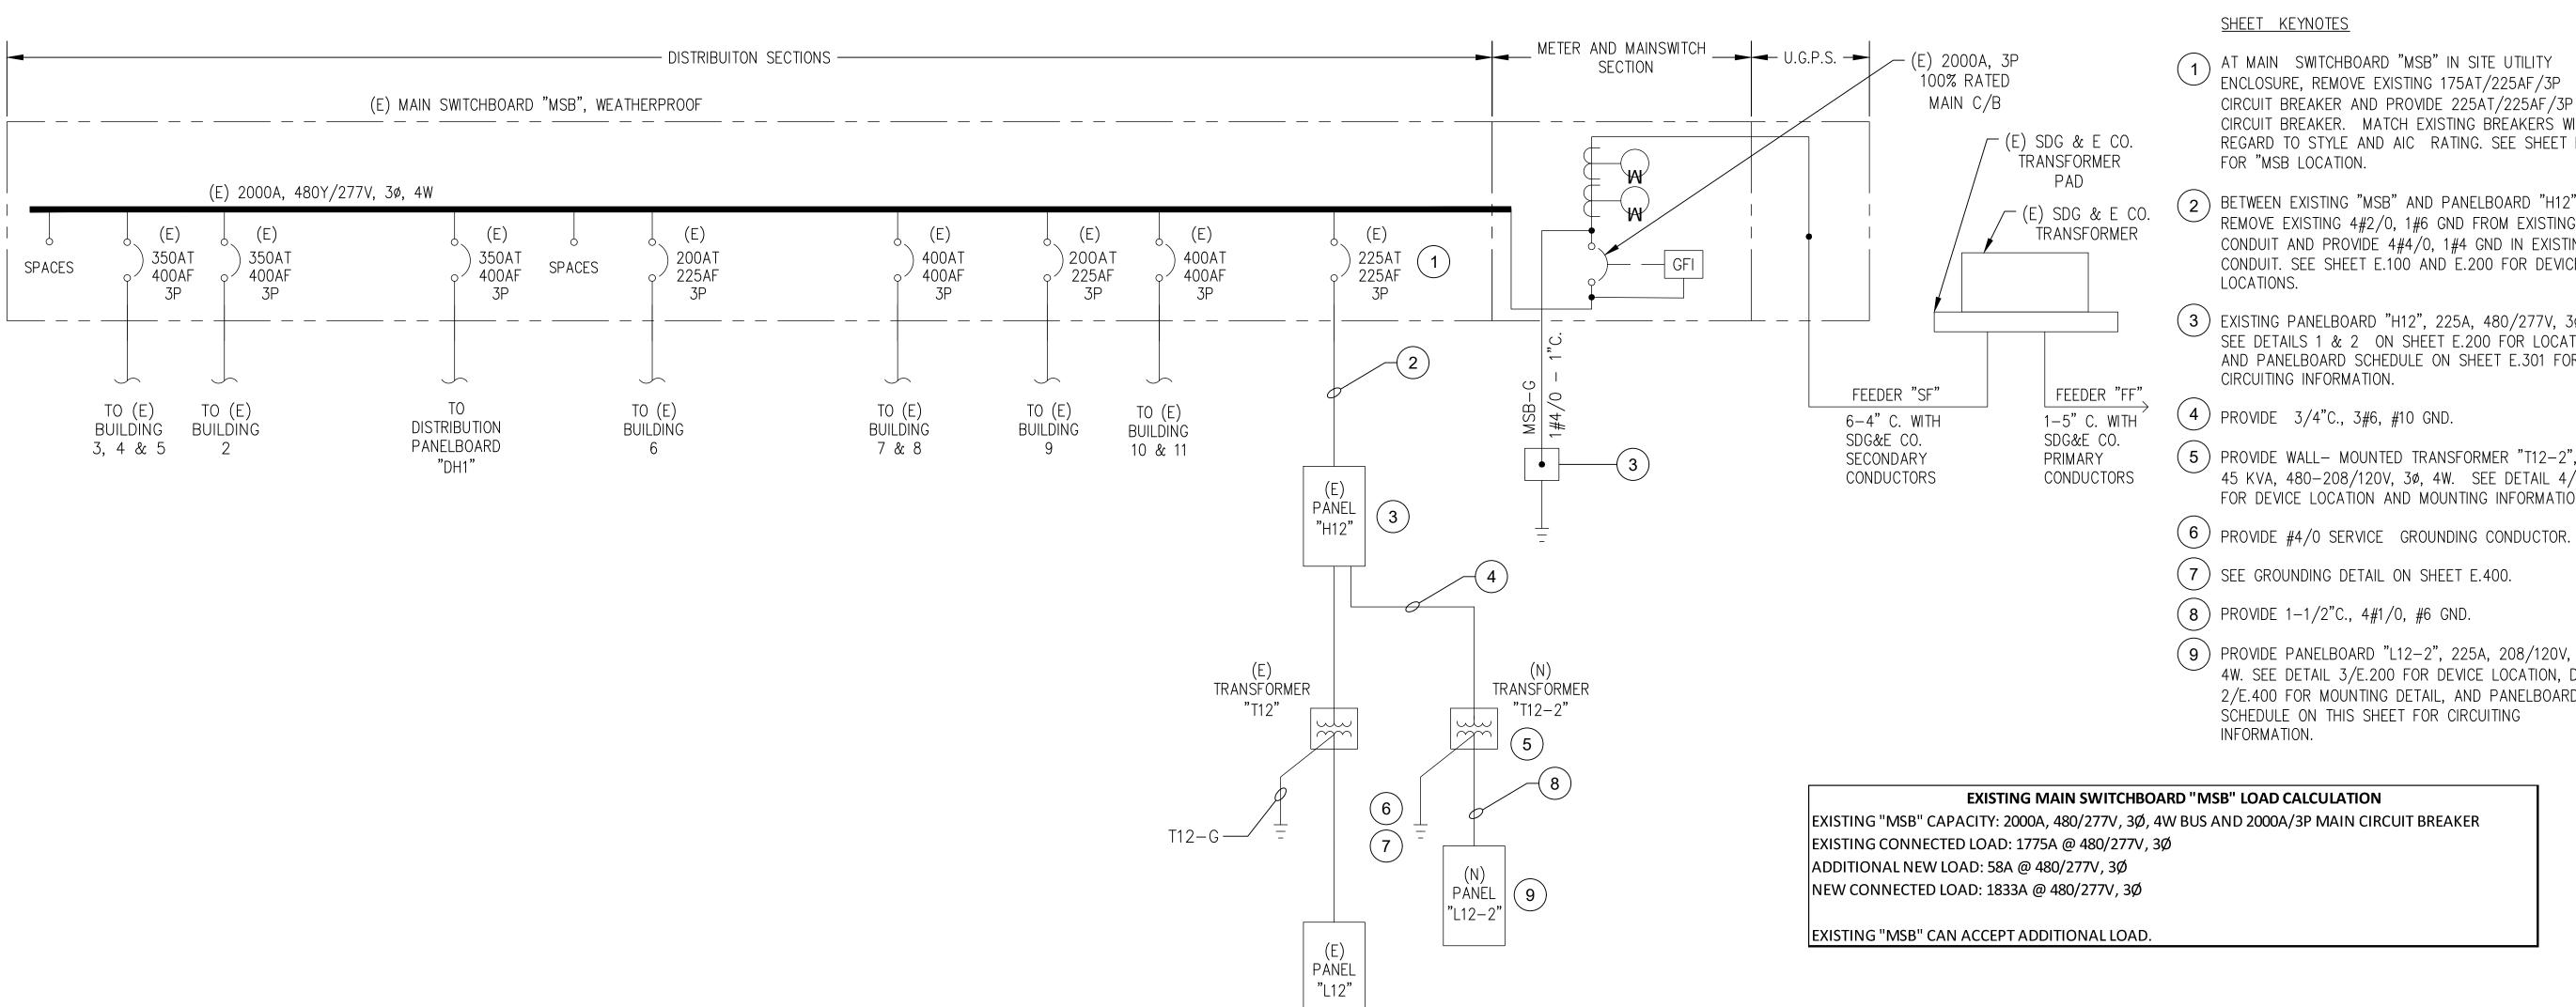

		LOCA	TION:	INTE	ERIO	R BL	DG 1	12, R	OON	12	Bus			208Y/120V, 3ø, 4W
(N) PANEL L12-2	2	MAIN:	125A								Rating:	22	5A	MOUNTING: RECESSED
		PANE	L MIN /	4.I.C	. RA	TING	= 10	KA	C					
LOCATION	VC	DLTAM	PS	CIR	BRK	٨	В	C	BRK	CIR	VO	LTAMF	PS	LOCATION
ECCATION	øΑ	øΒ	øС	Oii V	DIVIX	^	Ь)	DIVIX	Oil	øΑ	øΒ	øС	ECCATION
COOKTOP 1	5500			1	50	*			20	2				SPARE
COCKTOI I		5500		3	2P		*		20	4				SPARE
OVEN 1			4150	5	50			*	20	6				SPARE
OVENT	4150			7	2P	*				8				SPACE
COOKTOP 2		5500		9	50		*			10				SPACE
COOKTOP 2			5500	11	2P			*	20	12			540	NORTH WALL RECEPTS
OVEN 2	4150			13	50	*				14				SPACE
OVENZ		4150		15	2P		*			16				SPACE
REFRIGERATOR			1800	17	20			*	20	18			540	NORTH WALL RECEPTS
SPARE				19	20	*				20				SPACE
SPARE				21	20		*		20	22				SPACE
ISLAND STATION GFI RECS			360	23	20			*		24			41	CP-1
SPACE				25		*				26				SPACE
SPACE		_		27			*			28				SPACE
ISLAND STATION GFI RECS			360	29	20			*		30				SPACE

	øA =	13800
TOTAL CONNECTED VA =	42	KVA
+ 25% LCL =		KVA
TOTAL	42	KVA
CONNECTED LOAD =	117	Α
MINIMUM FEEDER SIZE =	117	Α

øB =	15150	øC =	13291

			/UA												
(E) PANEL H12	LOCATION: ELEC CLOSET 1206									BUS RATING: 225A			480Y/277V, 3ø, 4W		
NEW WORK		MAIN: 225A												MOUNTING: SURFACE	
		PANEL DEVICE MIN A.I.C. RATING =												JOB#	
LOCATION	/	/OLTAMP	S	CID	BRK /	Α	В	СВ	DDV	CID	V	VOLTAMPS		LOCATION	
LOCATION	øΑ	øΒ	øС	CIR		А	В		DIN	CIK	øΑ	øΒ	øС	LOCATION	
ELEC ROOM LIGHTS	1274			1	20	*			20	2	1274			LIGHTS ROOM 3	
SPARE				3	20		*		20	4		1274		LIGHTS ROOM 2	
SPARE				5	20			*	20	6				SPARE	
LIGHTS ROOM 5	1274			7	20	*			20	8				SPARE	
LIGHTS ROOM 4		1274		9	20		*		20	10				SPARE	
SPARE				11	20			*	20	12				SPARE	
	3573			13	20	*			20	14	3573			CU12-3	
CU 12-1		3573		15			*		20	16		3573			
			3573	17	3P			*	20	18			3573		
	3573			19	20	*			20	20	3573			CU12-4	
CU12-2		3573		21			*		20	22		3573			
			3573	23	3P			*	20	24			3573		
	15000			25	70	*				26				SPACE	
TRANSFORMER T-12		15000		27			*			28				SPACE	
			15000	29	3P			*	20+	30			2500	WH-1	
	15000			31	60+	*				32				SPACE	
(N) TRANSFORMER T-12-2		15000		33			*			34				SPACE	
			15000	35	3P			*		36				SPACE	
SPACE				37		*				38				SPACE	
SPACE				39			*			40				SPACE	
SPACE				41				*		42				SPACE	
	øA =	48114			øB =	468	340				øC =	46792			

NOTES: EXISTING CONNECTED LOAD IS 113A @ 480/277V, 3ø. ADDITIONAL LOAD

OF 58A @ 480/277V, 3ø IS TO BE ADDED TO THE PANELBOARD. RESULTANT

CONNECTED LOAD WILL BE 171A @ 480/277V, 3ø. THE PANELBOARD IS

EXISTING BREAKERS WITH REGARD TO STYLE AND AIC RATING.

+=PROVIDE CIRCUIT BREAKER AS INDICATED IN EXISTING SPACE. MATCH

CAPABLE OF ACCEPTING THE ADDITIONAL LOAD.

SINGLE LINE DIAGRAM & PANEL SCHEDULES SCALE: NONE

142 KVA

142 KVA

171 A

171 A

TOTAL CONNECTED VA =

CONNECTED LOAD =

MINIMUM FEEDER SIZE =

+ 25% LCL =

TOTAL



CIRCUIT BREAKER AND PROVIDE 225AT/225AF/3P CIRCUIT BREAKER. MATCH EXISTING BREAKERS WITH REGARD TO STYLE AND AIC RATING. SEE SHEET E.100

(2) BETWEEN EXISTING "MSB" AND PANELBOARD "H12", REMOVE EXISTING 4#2/0, 1#6 GND FROM EXISTING 3" CONDUIT AND PROVIDE 4#4/0, 1#4 GND IN EXISTING 3" CONDUIT. SEE SHEET E.100 AND E.200 FOR DEVICE

 $(\ 3\)$ EXISTING PANELBOARD "H12", 225A, 480/277V, 3ø, 4W. SEE DETAILS 1 & 2 ON SHEET E.200 FOR LOCATION AND PANELBOARD SCHEDULE ON SHEET E.301 FOR

(5) PROVIDE WALL- MOUNTED TRANSFORMER "T12-2", 45 KVA, 480-208/120V, 3ø, 4W. SEE DETAIL 4/E.200 FOR DEVICE LOCATION AND MOUNTING INFORMATION.

(9) PROVIDE PANELBOARD "L12-2", 225A, 208/120V, 3ø, 4W. SEE DETAIL 3/E.200 FOR DEVICE LOCATION, DETAIL 2/E.400 FOR MOUNTING DETAIL, AND PANELBOARD

> OOL DISTRICT ING VALLEY UNIFIED SCHOOS S ACADEMY CULINARY CLA E, LA MESA, CA 91941

17 inf obj 61 61 338 f t & e

OBRARCHITECTURE, INC. ALL RIGHTS RESERVED. THE ABOVE DRAWINGS, IDEAS, AND EMBODIED DESIGNS THEREIN ARE THE PROPERTY OF OBRARCHITECTURE, INC. AND SHALL NOT BE COPIED, REPRODUCED, DISCLOSED TO OTHERS C USED IN CONNECTION WITH ANY WORK OTHER THAN THE SPECIFIED PROJECT FOR WHICH THEY HAVE BEEN PREPARED, IN WHOLE OR IN PART, WITHOUT THE PRIOR WRITTEN AUTHORIZATION OF OBRARCHITECTURE, INC.


> SET LINE DIAGRAM & **DOCUMENT** SINGLE

EDULES

03.26.2019

LMSV - 001 Sheet No.

E.301

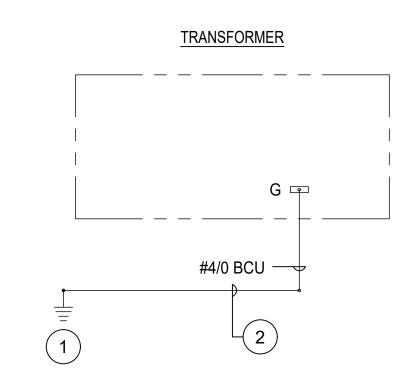


KEYNOTES

(1) GROUND ROD PER CEC 250. 3/4" DIA. X 10'-0" LONG.

2) #4/0 BARE COPPER (BCU) GROUND LOOP.

GROUNDING DIAGRAM (TYPICAL)

E.400 SCALE: NOT TO SCALE

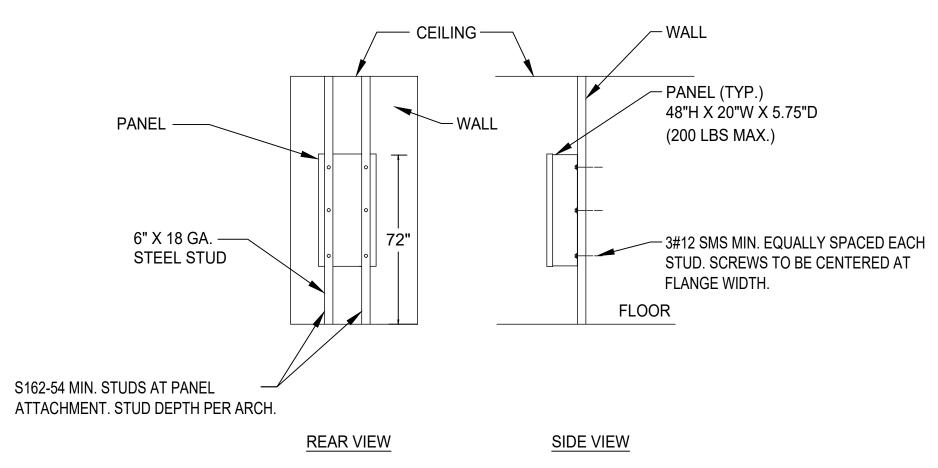

E.400 SCALE: NOT TO SCALE

LA MESA SPRING VALLEY UNIFIED SCHOOL DISTRICT LA MESA ARTS ACADEMY CULINARY CLASSROOM 4200 Parks avenue, la mesa, ca 91941

3817 Ray Stree info@obra w obrarchite t 619.564.7 f 619.568.3

OBRARCHITECTURE, INC. ALL RIGHTS RESERVED.
THE ABOVE DRAWINGS, IDEAS, AND EMBODIED
DESIGNS THEREIN ARE THE PROPERTY OF
OBRARCHITECTURE, INC. AND SHALL NOT BE
COPIED, REPRODUCED, DISCLOSED TO OTHERS OR
USED IN CONNECTION WITH ANY WORK OTHER
THAN THE SPECIFIED PROJECT FOR WHICH THEY
HAVE BEEN PREPARED, IN WHOLE OR IN PART,
WITHOUT THE PRIOR WRITTEN AUTHORIZATION
OF OBRARCHITECTURE, INC.

ELECTRICAL DETAILS

SET

BID DOCUMENT

03.26.2019

LMSV - 001 Job No.
Sheet No.

E.400

9565 WAPLES STREET, SUITE 100 SAN DIEGO, CA 92121 (858) 824-1761 FAX (858) 824-1768 EPI PROJECT #140-77E

